
PRELIMINARY PLAN FOR TOOMEY PROPERTY

BALTIMORE HUNDRED SUSSEX COUNTY, DELAWARE PREPARED FOR: CHRISTOPHER LAND, LLC

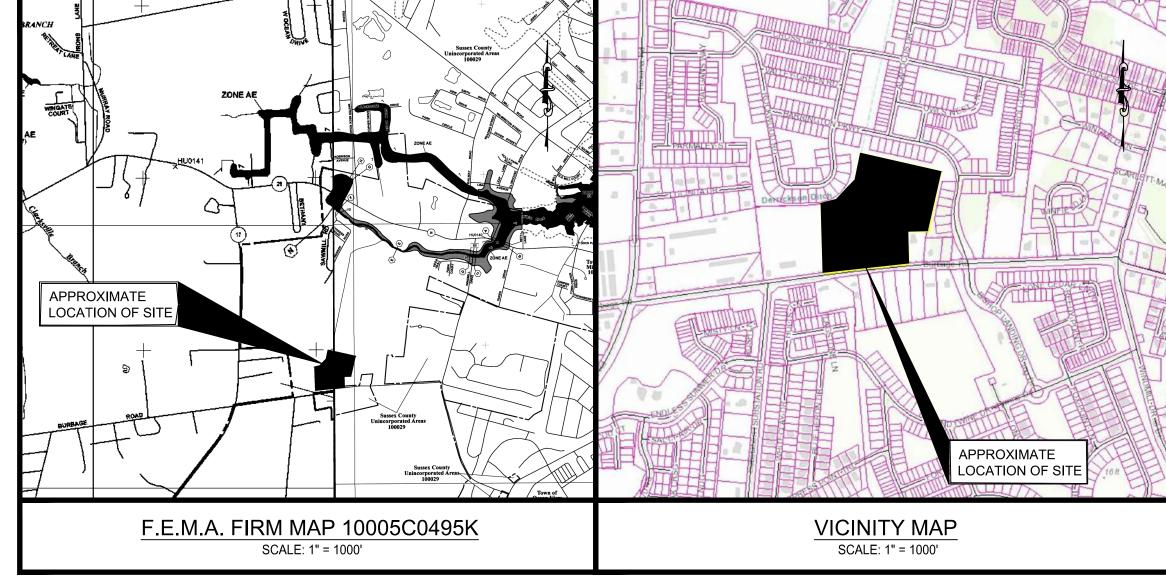

	LEGEND		SCALE: 1" = 100'
DESCRIPTION	EXISTING	PROPOSED	
PAVEMENT			
ROAD CENTERLINE			
RIGHT-OF-WAY	ROW	ROW	
PROPERTY LINE			
SANITARY SEWER	8SS	8SS	
SANITARY SEWER MANHOLE	S	S	
FLOW DIRECTION ARROW	◄	-	
8' WIDE WALKING PATH			
5' WIDE SIDEWALK			
WATER LINE	8W	8W	
FIRE HYDRANT	>	—	
STORMDRAIN PIPE	SD	SD	
CATCH BASIN			
STREET LIGHTS	N/A	\	
STREET SIGNS	N/A	‡	
EASEMENT	N/A		
BUILDING RESTRICTION LINE			
TREE LINE	~~~~~~~	~~~~~~~	
TAX DITCH RIGHT OF WAY		N/A	
TAX DITCH BUFFER		N/A	
ZONING LINE		N/A	



SITE DATA COLUMN

(703) 352-5950

(302) 376-8833

PROPERTY INFORMATION/OWNER: TOOMEY, LLC 36003 BURBAGE ROAD FRANKFORD, DE 19945 TAX PARCEL NO: T.P. 134-12.00-376.00 TOTAL AREA: 13.90 +/- ACRES D.B. 3894, PG. 205

DEVELOPER/APPLICANT:
THE CHRISTOPHER COMPANIES (CHRISTOPHER LAND, LLC)
10461 WHITE GRANITE DRIVE, SUITE 250
OAKTON, VA 22124

B. ENGINEER:
CIVIL ENGINEERING ASSOCIATES, LLC
55 WEST MAIN STREET
MIDDLETOWN, DE 19709

4. AGENCY:
SUSSEX CONSERVATION DISTRICT
23818 SHORTLY ROAD
GEORGETOWN, DE 19947
(302) 856-2105

5. EXISTING ZONING: RPC (RESIDENTIAL PLANNED COMMUNITY)

. PROJECT BENCHMARK: N: 197169.99 E: 740132.04 ELEV. = 15.27

605,444.74 S.F. +/- = 13.90 AC. +/-

94,231.60 S.F. +/- = 2.16 AC. +/-

511,213.20 S.F. +/- = 11.74 AC. +/-

253,627.33 S.F. +/- = 5.82 AC. +/-

3,174.47 S.F. +/- = 0.07 AC. +/-

4,333.76 S.F. +/- = 0.10 AC. +/-

107,365.19 S.F. +/- = 2.46 AC. +/-

21,251.33 S.F. +/- = 0.49 AC. +/-

121,476.11 S.F. +/- = 2.79 AC. +/-

5,735.43 S.F. +/- = 0.13 AC. +/-

5,305.70 S.F. +/- = 0.12 AC. +/-

9. MAXIMUM BUILDING HEIGHT: 42 FT (MPC CODE)

10. PROPOSED USE: RESIDENTIAL

11. AREAS:

TOTAL AREA
COMMERCIAL AREA
COM. ROW DEDICATION
COM. PERMANENT EASEMENT
GROSS RESIDENTIAL AREA
LOT AREA
RES. ROW DEDICATION
RES. PERMANENT EASEMENT
TOWN/PRIVATE ROW
STORMWATER AREA

OPEN SPACE AREA

NET RESIDENTIAL AREA

482,510.84 S.F. +/- = 11.08 AC. +/
12. LOTS: NUMBER OF DWELLING UNITS PERMITTED:
482,510.84 S.F. / 5,000 S.F. = 96 LOTS
11.08 AC. * 6.2 = 68 LOTS

LOTS PERMITTED = 68 LOTS

LOTS PROPOSED = 50 LOTS

50 RESIDENTIAL LOTS
DENSITY = 4.51+/- LOTS/ACRE (50 LOTS/11.08 ACRES)

13. PARKING:

OFF-STREET PARKING REQUIRED:
2 SPACES PER DWELLING UNIT
(2 SPACES)*(50 UNITS) = 100 PARKING SPACES
OVERFLOW PARKING REQUIRED:
0.5 SPACES PER DWELLING UNIT
(0.5 SPACES)*(50 UNITS) = 25 PARKING SPACES

(3 SPACES)*(50 UNIT) = 150 PARKING SPACES

TOTAL REQUIRED PARKING = 125 PARKING SPACES

OFF-STREET PARKING PROPOSED:

3 SPACES PER DWELLING UNIT

17 PARKING LOT SPACES
TOTAL PROPOSED PARKING = 167 PARKING SPACES

14. UTILITIES: WATER: TIDEWATER UTILITIES

15. FIRE LANES:

FIRE LANES:
ALL FIRE LANES, FIRE HYDRANTS AND FIRE CONNECTIONS SHALL BE MARKED IN ACCORDANCE WITH DELAWARE FIRE PREVENTION REGULATIONS.

SANITARY SEWER: SUSSEX COUNTY

16. THE SITE IS NOT IMPACTED BY THE 100-YEAR FLOODPLAIN PER FEMA MAP NO. 10005C0495K DATED MARCH 16, 2015 AND FEMA MAP NO. 10005C0511K DATED MARCH 16, 2015.

SITE DATA COLUMN CONTINUED

7. WETLANDS:
A WETLAND DELINEATION WAS PERFORMED BY JAMES C. MCCULLEY
WATERSHED ECO, LLC IN JULY 2021. THERE ARE NO WETLANDS ON SITE.

18. OPEN SPACE:

REQUIRED = NO LESS THAN 20% OF THE GROSS AREA

= (11.74 AC.)*(0.20) = 2.35 AC.

PROVIDED = 3.28 AC. (3.28 AC./11.74 AC. = 0.28 = 28%)

REQUIRED = 25% OF REQUIRED OPEN SPACE = $(2.35 \text{ AC.})^*(0.25) = 0.59 \text{ AC.}$ PROVIDED = 0.68 AC.

U.S.G.S. HORIZONTAL DATUM NAVD 83 SPC

20. BOUNDARY AND TOPOGRAPHY: BOUNDARY & TOPOGRAPHY WAS

PERFORMED BY CIVIL ENGINEERING ASSOCIATES IN OCTOBER 2021.

19. TOPOGRAPHIC REFERENCE: U.S.G.S. VERTICAL DATUM NAVD 88

21. COMMERCIAL AREA WILL BE SUBMITTED FOR SITE PLAN APPROVAL AT A LATER DATE.

INDEX OF DRAWINGS

SHEET NUMBER
T-1 COVER SHEET
T-2 CONSTRUCTION & GENERAL NOTES
EX-1 EXISTING CONDITIONS PLAN
C-1 SITE PLAN
G-1 GRADING PLAN
U-1 UTILITY PLAN
D-1 THROUGH D-2 CONSTRUCTION DETAILS

RECORD PLAN

LANDSCAPE PLAN

CERTIFICATION OF OWNERSHIP:

L-1 THROUGH L-2

I HEREBY CERTIFY THAT I AM THE OWNER OF THE PROPERTY DESCRIBED AND SHOWN ON THIS PLAN, THAT THE PLAN WAS MADE AT MY DIRECTION, THAT ALL STREETS HEREON AND NOT HERETOFORE DEDICATED ARE TO BE DEDICATED TO THE PUBLIC USE AND OWNERSHIP TRANSFERRED TO THE HOMEOWNERS ASSOCIATIONS VIA SEPARATE SUBSEQUENT DEED OF DEDICATION AND TRANSFER, TO BE APPROVED BY THE TOWN OF MILLVILLE.

TOOMEY, LLC

SIGNATURE_____ DATE____

CERTIFICATION OF PLAN ACCURACY:

I RONALD H. SUTTON, JR. HEREBY CERTIFY THAT I AM A REGISTERED PROFESSIONAL ENGINEER IN THE STATE OF DELAWARE, THAT THE INFORMATION SHOWN HEREON HAS BEEN PREPARED UNDER MY SUPERVISION AND TO THE BEST OF MY KNOWLEDGE AND BELIEF REPRESENTS GOOD SURVEYING PRACTICES AS REQUIRED BY APPLICABLE LAWS OF THE STATE OF DELAWARE.

RONALD H. SUTTON JR., P.E.

DATE

TOWN OF MILLVILLE:

TOWN OF MILLVILLE APPROVAL.

SIGNATURE_____ DATE____

| The companies are a companies and the

VIL ENGINEEKI SSOCIATES, LLO • SURVEYING • CONSTRUCTION SERVICES

55 W. MAIN STREET MIDDLETOWN, DE 19709

ROPERT

MEY PRO

NOVEMBER 23, 2022

DESIGNED BY:
RT
RHS
FILE:
PRELIM_COVER.DWG

SHEET NO.:

T-1

CONSTRUCTION NOTES:

- 1. THESE DRAWINGS SHOW INFORMATION OBTAINED FROM THE AVAILABLE RECORDS REGARDING PIPES, CONDUITS, TELEPHONE LINES, AND OTHER STRUCTURES AND CONDITIONS WHICH EXIST ALONG THE LINES OF WORK AT AND BELOW THE SURFACE OF THE GROUND. THE OWNER AND ENGINEER DISCLAIM ANY RESPONSIBILITIES FOR THE ACCURACY OR COMPLETENESS OF SAID INFORMATION BEING SHOWN ONLY FOR THE CONVENIENCE OF THE CONTRACTOR WHO MUST VERIFY THE INFORMATION TO HIS OWN SATISFACTION. IF THE CONTRACTOR RELIES ON SAID INFORMATION, HE DOES SO AT HIS OWN RISK. THE GIVING OF THE INFORMATION ON THE CONTRACT DRAWINGS WILL NOT RELIEVE THE CONTRACTOR OF HIS OBLIGATIONS TO SUPPORT AND PROTECT ALL PIPES, CONDUITS, TELEPHONE LINES AND OTHER STRUCTURES.
- 2. ALL MATERIALS AND METHODS OF CONSTRUCTION SHALL CONFORM TO THE DRAWINGS, TIDEWATER UTILITIES INCORPORATED (TUI) SPECIFICATIONS, LOCAL BUILDING CODES, AND THE STANDARD SPECIFICATIONS.
- 3. WATER LINES WILL BE INSTALLED AT A DEPTH THAT WILL PROVIDE 48" COVER OVER THE PIPES BELOW PROPOSED GRADE UNLESS SHOWN OTHERWISE ON THESE PLANS OR DIRECTED OTHERWISE BY THE ENGINEER IN THE FIELD.
- 4. ALL DISTURBED AREAS SHALL BE SMOOTHLY GRADED TO PROMOTE POSITIVE DRAINAGE AND STABILIZED WITH TOPSOIL, SEED AND MULCH. IF SETTLEMENT OCCURS, TOPSOIL, SEEDING AND MULCH SHALL BE REPEATED UNTIL SETTLEMENT SUBSIDES. (SEE EROSION AND SEDIMENT CONTROL DETAILS AND SPECIFICATIONS.)
- 5. THE CONTRACTOR SHALL NOTIFY THE FOLLOWING TWO (2) WEEKS PRIOR TO THE START OF CONSTRUCTION AND SHALL COORDINATE ALL CONSTRUCTION PHASES WITH THEM:


SHOULD ANY DAMAGE OCCUR TO EXISTING UTILITIES, IT SHALL BE REPAIRED SOLELY AT THE CONTRACTOR'S EXPENSE.


- 6. CONTRACTOR SHALL CONTACT DELAWARE ELECTRIC COOPERATIVE AT 1-302-349-9090 PRIOR TO COMMENCING WORK WITHIN THE PROXIMITY OF OVERHEAD HIGH-VOLTAGE POWER LINES.
- 7. ALL DRAINAGE STRUCTURES AND TRENCHES SHALL REMAIN FUNCTIONAL DURING CONSTRUCTION.
- 8. THE OWNER IS RESPONSIBLE FOR THE ACQUISITION OF ALL EASEMENT, BOTH TEMPORARY AND PERMANENT.
- 9. ALL WATER VALVES, BOXES AND HYDRANTS SHALL BE SET AND ADJUSTED TO FINISHED GRADE.
- 10. TRENCHES SHALL NOT REMAIN OPEN OVERNIGHT. IF IT IS NECESSARY FOR TRENCHES TO REMAIN OPEN, STEEL PLATES CAPABLE OF BEARING TRAFFIC SHALL BE USED TO COMPLETELY COVER THE TRENCH OPENINGS.
- 11. WATER MAINS SHALL HAVE A MINIMUM 10 FOOT HORIZONTAL AND 18 INCH VERTICAL SEPARATION FROM SANITARY SEWER. WHERE MINIMUM VERTICAL SEPARATION DISTANCES CANNOT BE MAINTAINED, SANITARY SEWER MATERIALS SHALL BE WATER WORKS GRADE 150 PSI PRESSURE RATED PIPE MEETING AWWA STANDARDS. PRESSURE TEST RESULTS SHALL BE PROVIDED ON THE AS-BUILT DRAWINGS.
- 12. THE CONTRACTOR ASSUMES ALL RESPONSIBILITY FOR ANY DEVIATION FROM THESE PLANS.
- 13. ANY PROPERTY LINE MONUMENTATION DISTURBED DURING CONSTRUCTION SHALL BE REPLACED SOLELY AT THE CONTRACTOR'S EXPENSE.
- 14. THE CONTRACTOR SHALL VERIFY EXISTING INVERTS PRIOR TO CONSTRUCTION OF UNDERGROUND UTILITIES. TEST PITTING OF EXISTING LINES PRIOR TO CONSTRUCTION, IF NECESSARY, SHALL BE COORDINATED WITH THE OWNER.
- 15. THE CONTRACTOR SHALL VERIFY HORIZONTAL AND VERTICAL SURVEY CONTROL PRIOR TO STAKING OUT CONSTRUCTION. ANY DISCREPANCIES SHALL BE BROUGHT TO THE ATTENTION OF THE ENGINEER PRIOR TO PROCEEDING WITH WORK.

GENERAL NOTES:

NECESSARY.

- 1. THE SIDEWALK AND MULTI-USE PATH SHALL BE MAINTAINED BY THE DEVELOPER. THE STATE AND/OR TOWN OF MILLVILLE ASSUMES NO MAINTENANCE RESPONSIBILITY OF THE SIDEWALK AND MULTI-USE PATH.
- 2. MAINTENANCE OF THE STREETS WILL BE THE RESPONSIBILITY OF THE DEVELOPER. THE STATE AND/OR TOWN OF MILLVILLE ASSUMES NO RESPONSIBILITY FOR THE FUTURE MAINTENANCE OF THESE STREETS.
- 3. THE SUSSEX CONSERVATION DISTRICT RESERVES THE RIGHT TO ADD, MODIFY OR DELETE ANY EROSION AND SEDIMENT CONTROL MEASURES AT IT DEEMS
- 4. THE SUSSEX CONSERVATION DISTRICT RESERVES THE RIGHT TO ENTER PRIVATE PROPERTY FOR PURPOSES OF PERIODIC INSPECTION.
- 5. PUBLIC OPEN SPACE, GREEN SPACE, STORMWATER MANAGEMENT AREAS, SIDEWALKS, MULTI USE PATH AND STREETS NOT DEDICATED SHALL BE MAINTAINED BY THE DEVELOPER.
- 6. THE DEVELOPER HEREBY GRANTS A SEWER EASEMENT IN FAVOR OF SUSSEX COUNTY WHICH INCLUDES ALL ROADWAYS, STREETS, ALLEYS FOR THE PURPOSE TO CONSTRUCT, MAINTAIN AND REPAIR UNDERGROUND PIPE, LINES AND MAINS FOR THE PURPOSE OF CONVEYING SEWER THROUGH THE LANDS. ADDITIONAL RIGHTS AND RESPONSIBILITIES OF SUSSEX COUNTY WILL BE MORE FULLY DETAILED IN A SEPARATE DEED OF EASEMENT TO BE RECORDED.
- 7. THE DEVELOPER HEREBY GRANTS A WATER EASEMENT IN FAVOR OF TIDEWATER UTILITIES, INC., WHICH INCLUDES ALL ROADWAYS, STREETS, ALLEYS FOR THE PURPOSE TO CONSTRUCT, MAINTAIN AND REPAIR UNDERGROUND PIPE, LINES AND MAINS FOR THE PURPOSE OF CONVEYING WATER SERVICE TO THE RESIDENTIAL AREAS SHOWN. ADDITIONAL RIGHTS AND RESPONSIBILITIES OF TIDEWATER UTILITIES, INC. WILL BE MORE FULLY DETAILED IN A SEPARATE DEED OF EASEMENT TO BE RECORDED.
- 8. ALL LOTS SHALL BE CONNECTED TO THE COMMUNITY-WIDE OPEN SPACE NETWORK VIA SIDEWALKS, PATHWAYS, AND/OR PUBLIC STREETS. A PLANNED OPEN SPACE OF ONE QUARTER ACRE OR LARGER INCLUDING OPEN GREENS, POCKET PARKS, SEATING AREAS AND TRAILS MUST BE WITHIN 1,500 FEET OF EVERY SINGLE-FAMILY DETACHED LOT MEASURED FROM THE CENTER OF THE LOT TO THE CENTER OF THE OPEN SPACE.
- 9. STREET LIGHTING DESIGN AND LAYOUT WILL BE PROVIDED BY DELAWARE ELECTRIC COOPERATIVE (DEC).

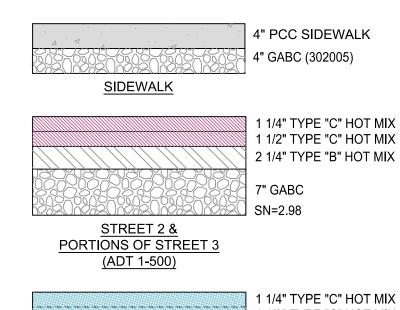


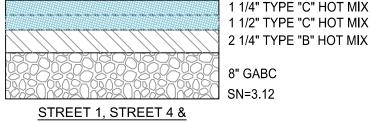

PORTIONS OF STREET 3

(ADT 501-1000)

TYPICAL PAVEMENT SECTIONS

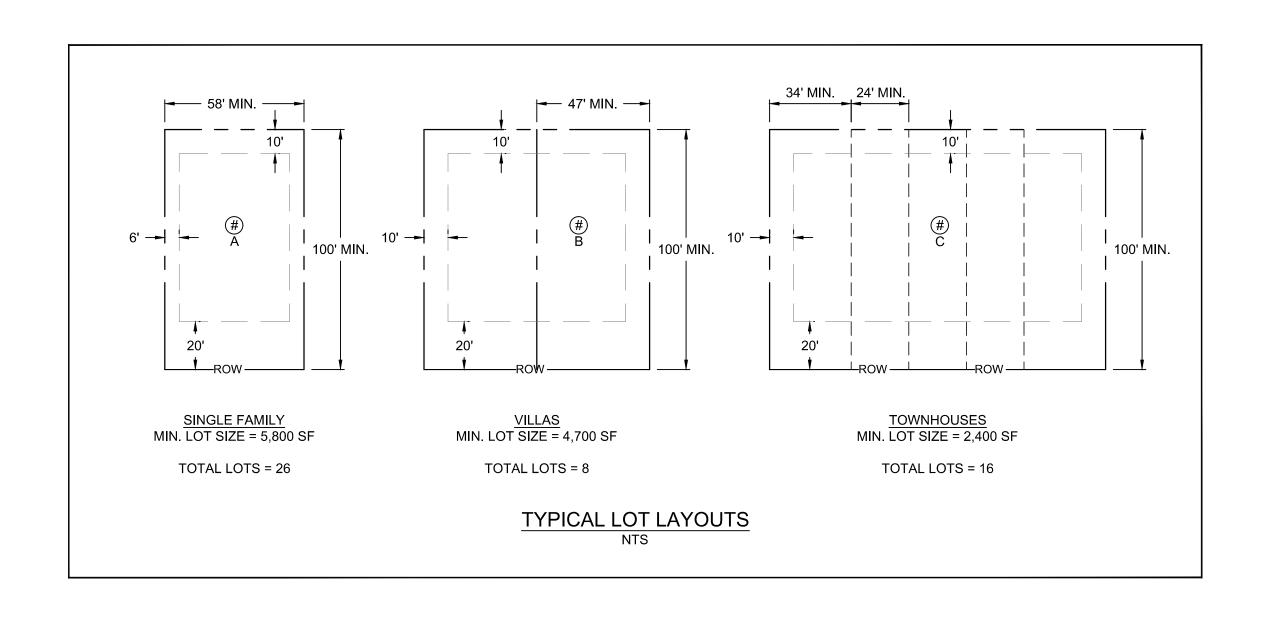

PHONE (302) 376-8833

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NOVEMBER 23, 2022
IGNED BY:
APPROVED BY:

DESIGNED BY:

RT


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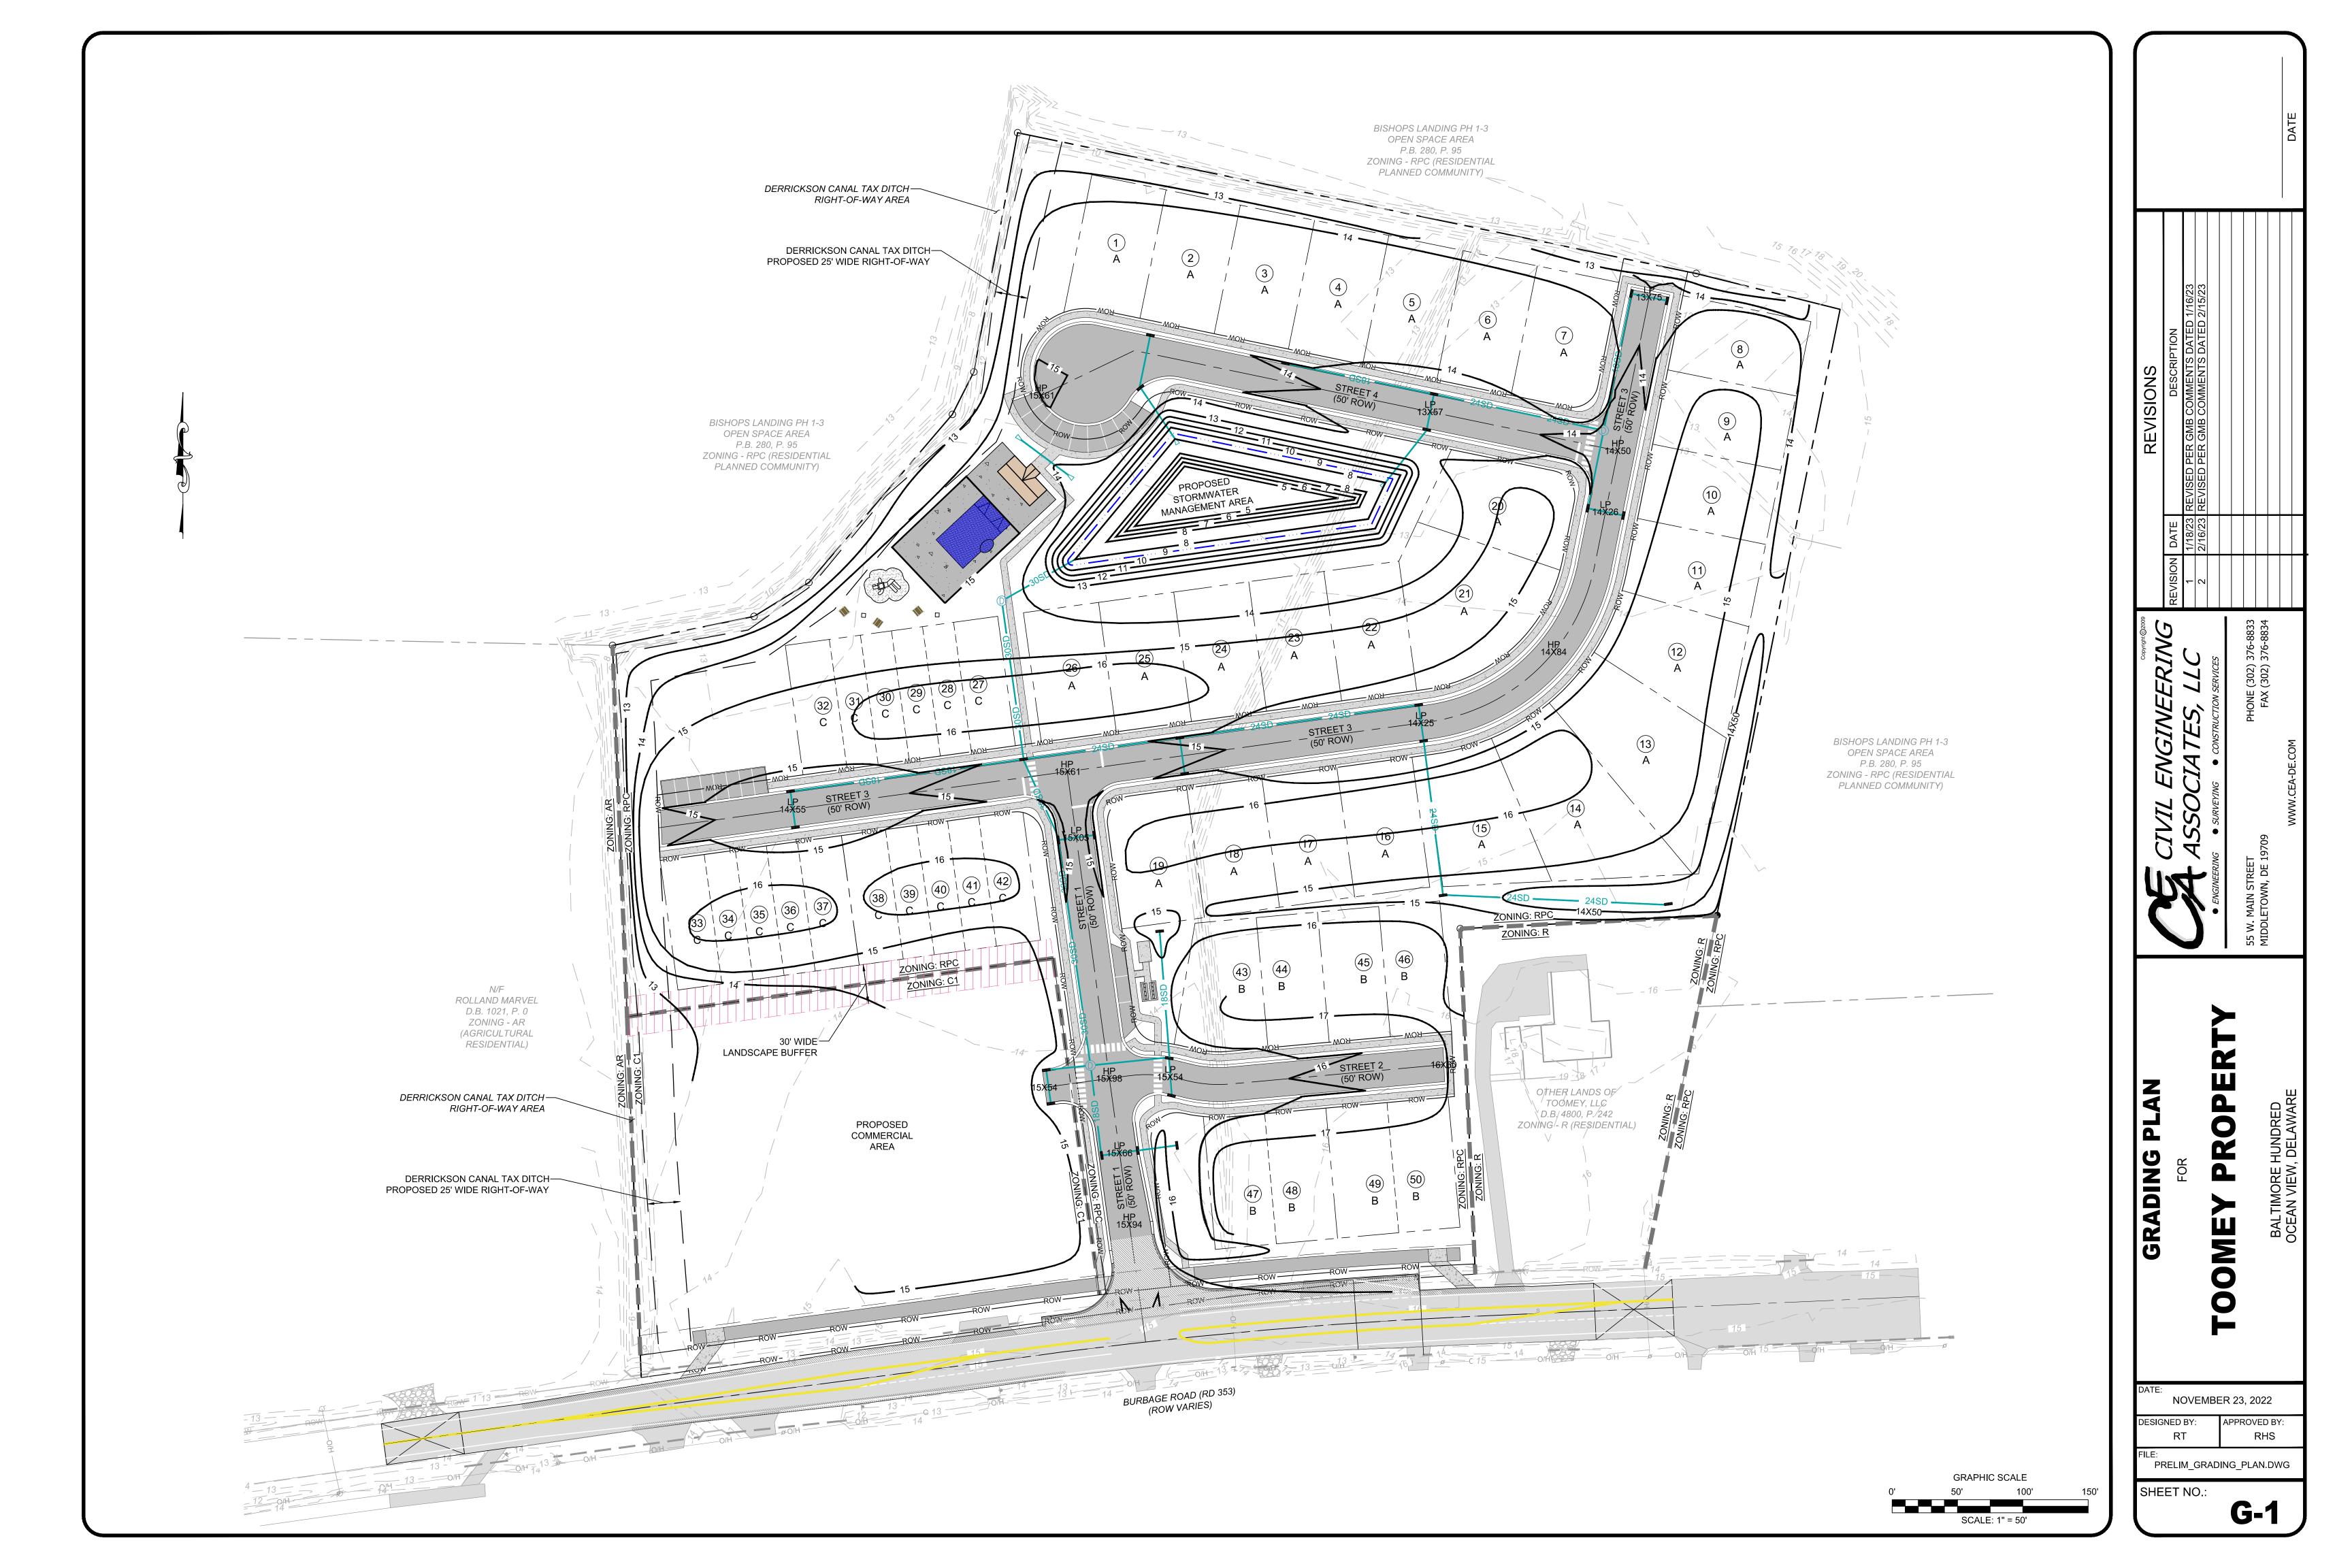
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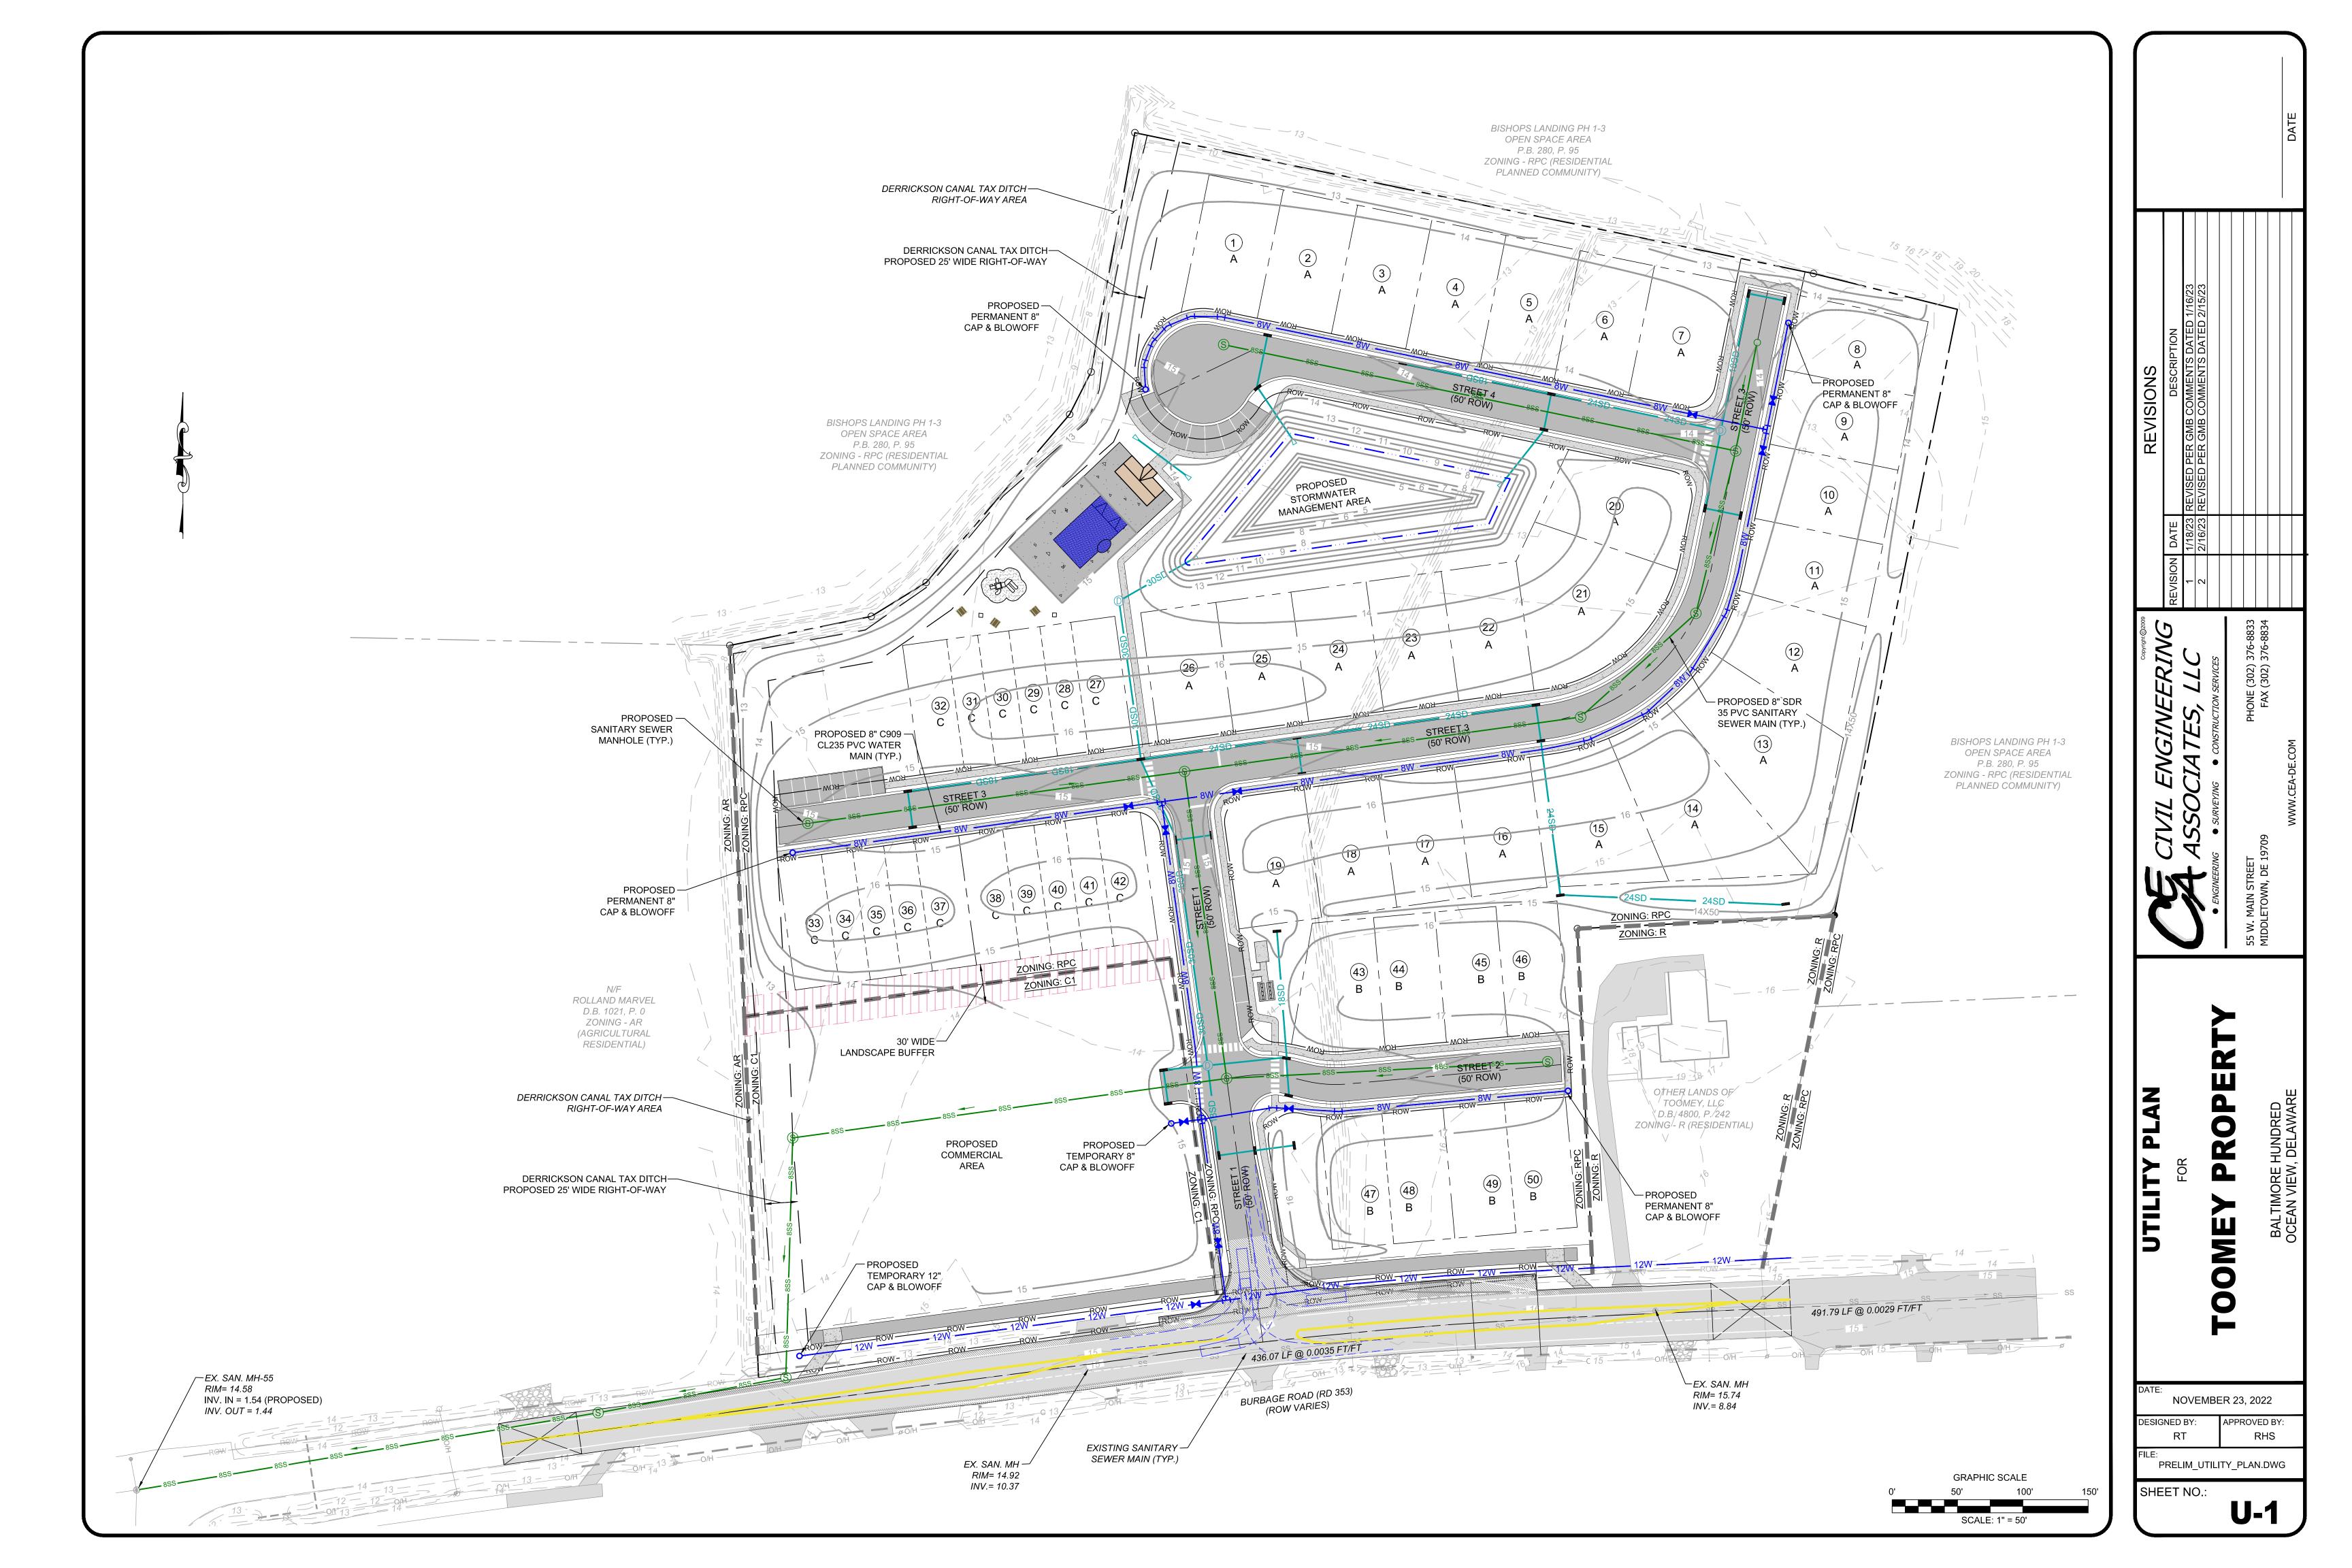
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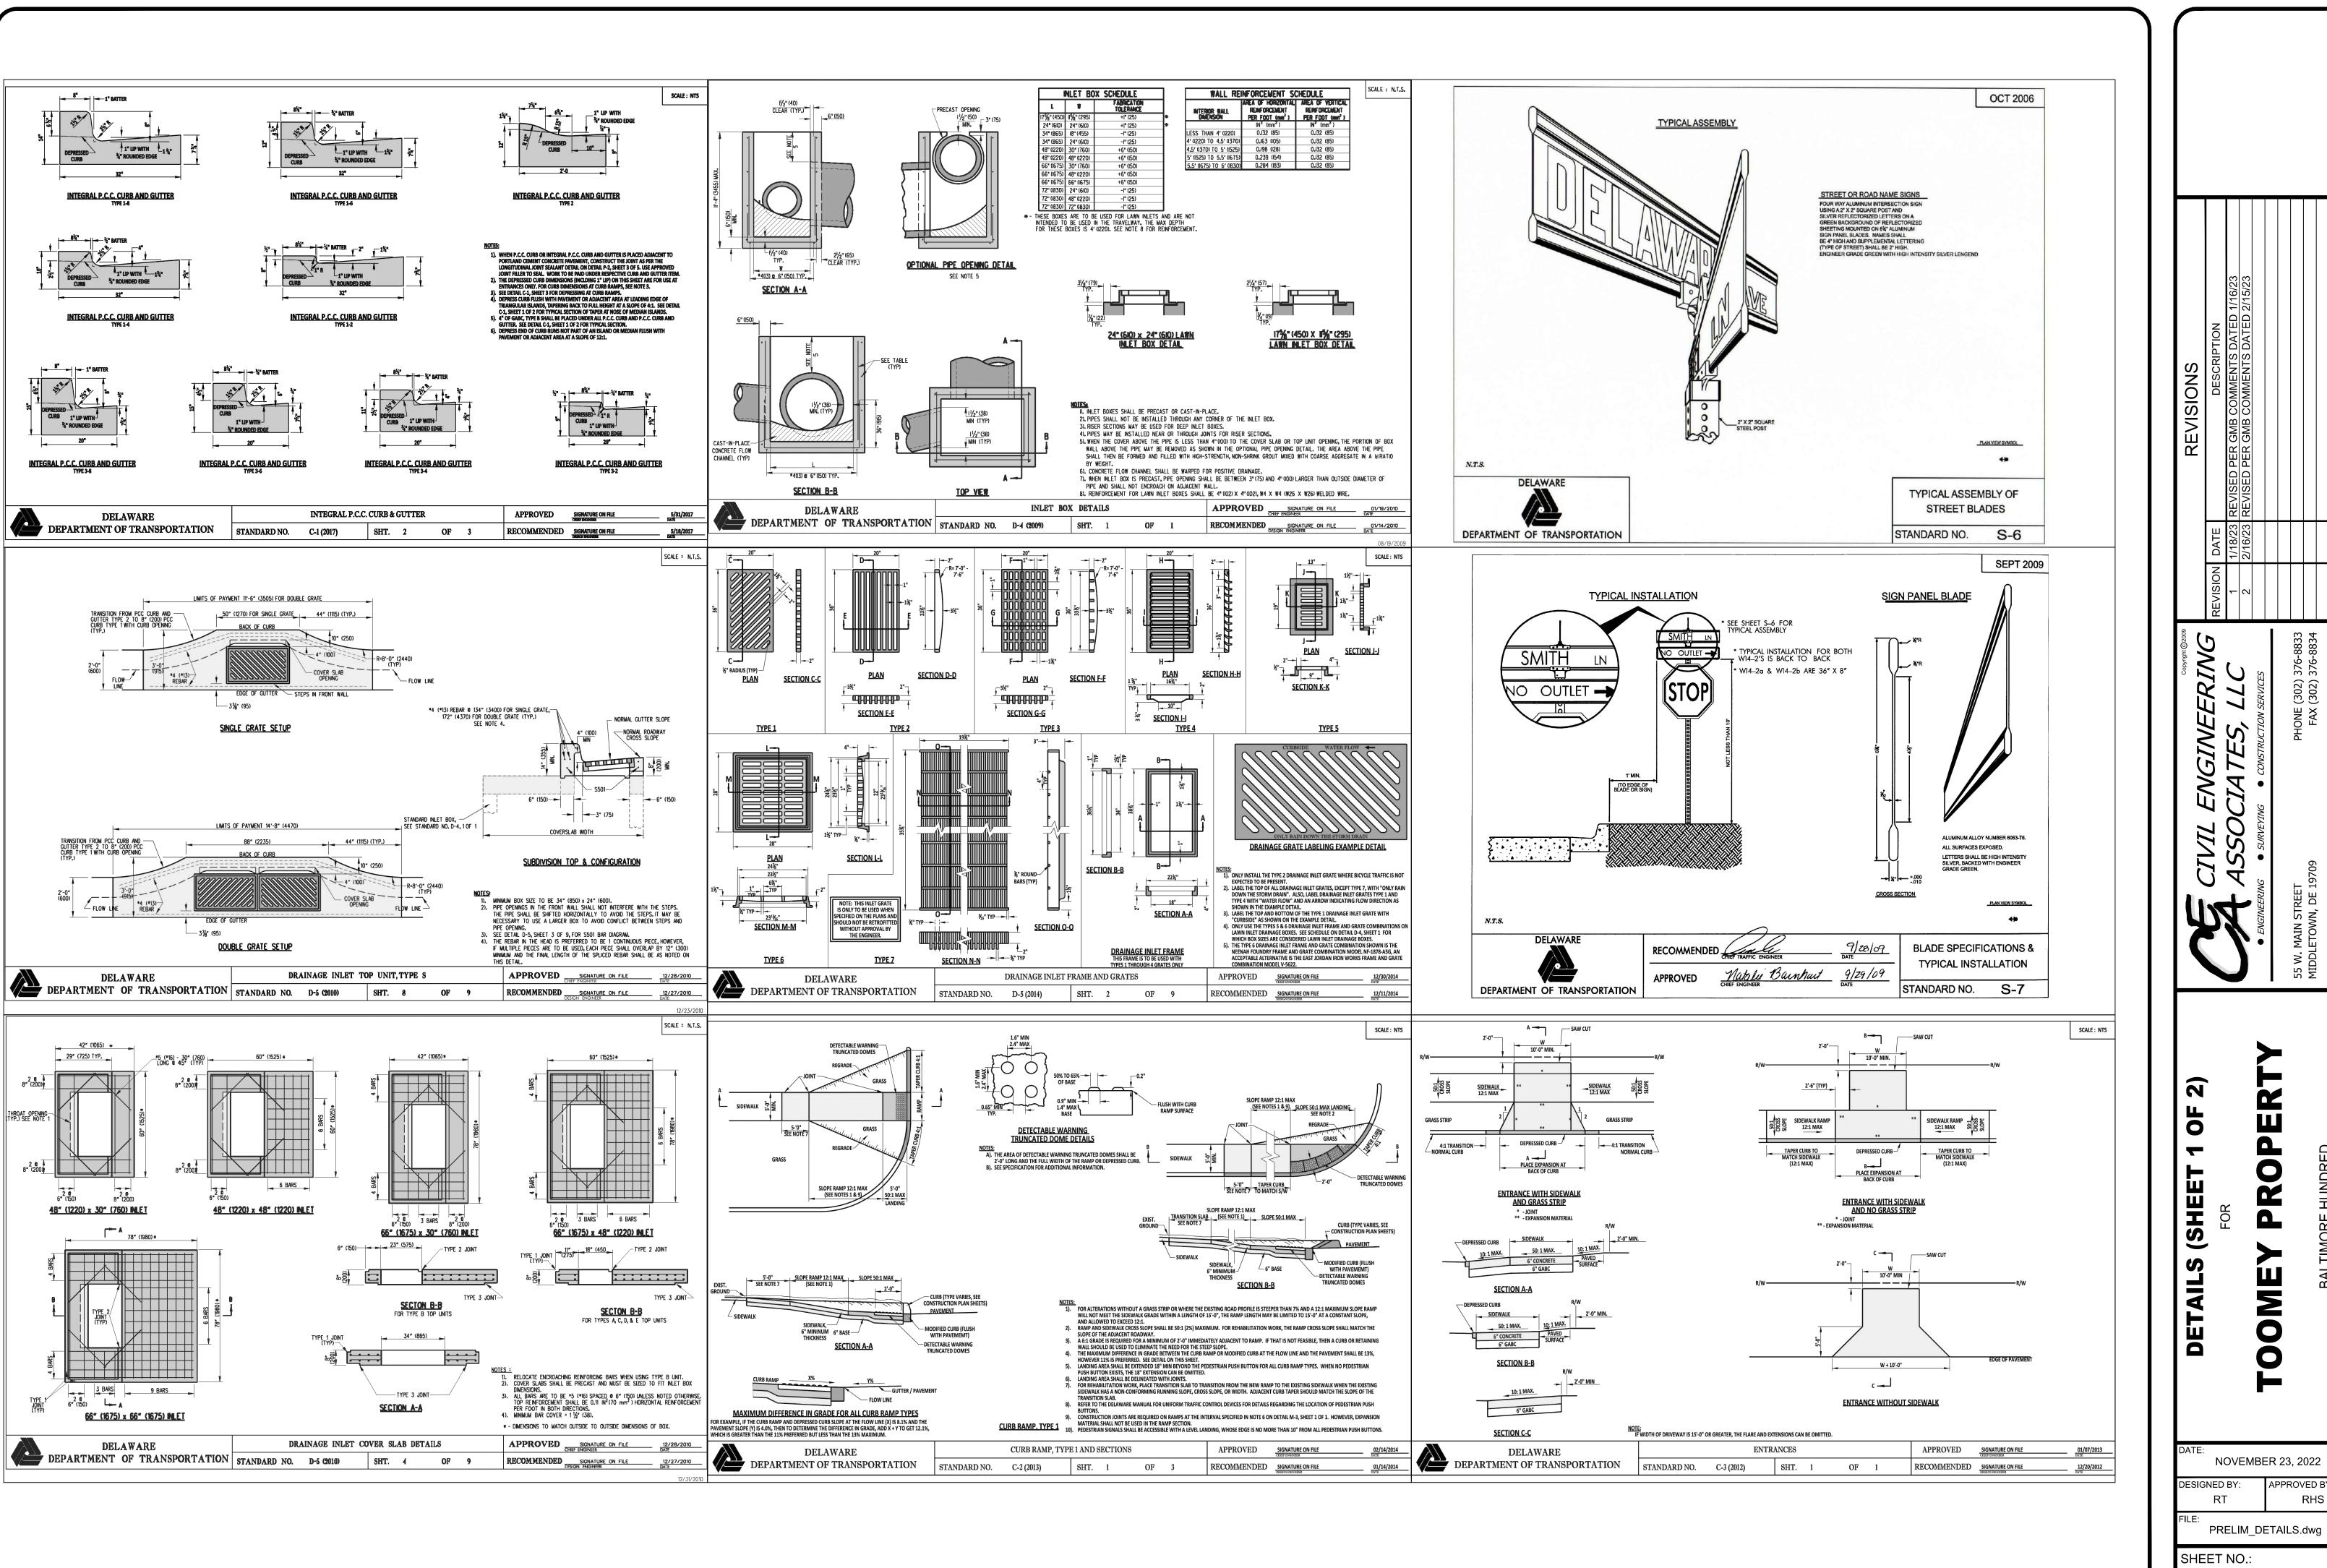
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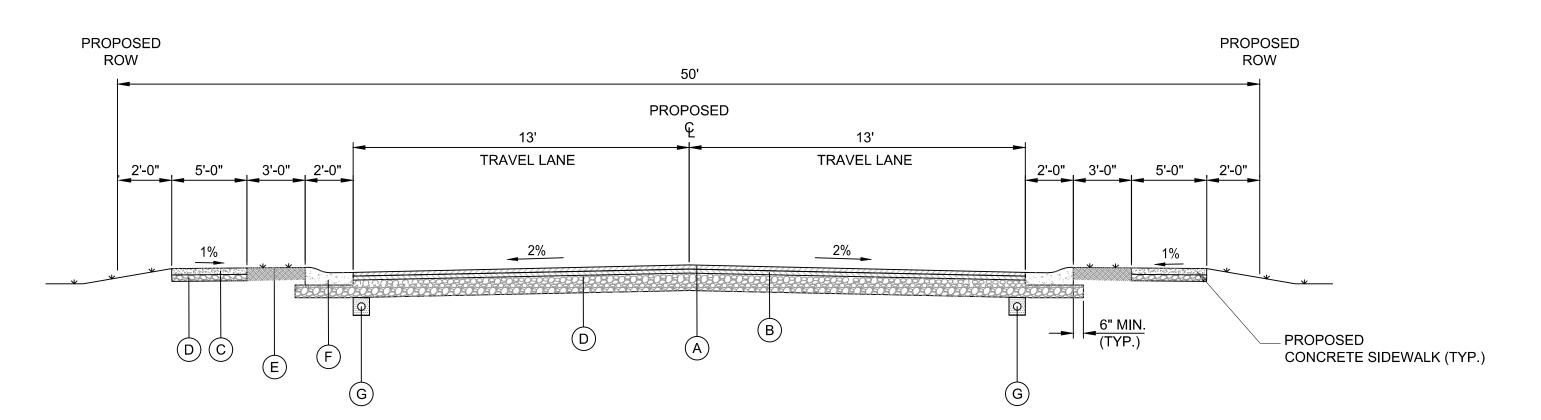
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APPROVED BY: RHS




TYPICAL ROAD SECTION

LEGEND:

- A ITEM 401651 SUPERPAVE TYPE C. 160 GYRATION. PG 70-22
- (B) ITEM 401654 SUPERPAVE TYPE B. 160 GYRATION. PG 70-22
- C ITEM 705001 P.C.C. SIDEWALK. 4" DEPTH
- (D) ITEM 302007 GRADED AGGREGATE BASE COURSE. TYPE B
- GRASS STRIP (WIDTH AS NOTED) ITEM 733002 - TOPSOILING. 6" DEPTH ITEM 734013 - PERMANENT GRASS SEEDING. DRY GROUND ITEM - 735006 - MULCHING. STRAW
- (F) ITEM 701011 INTEGRAL P.C.C. CURB AND GUTTER. TYPE 2
- (G) ITEM 715001 PERFORATED PIPE UNDERDRAINS. 6"

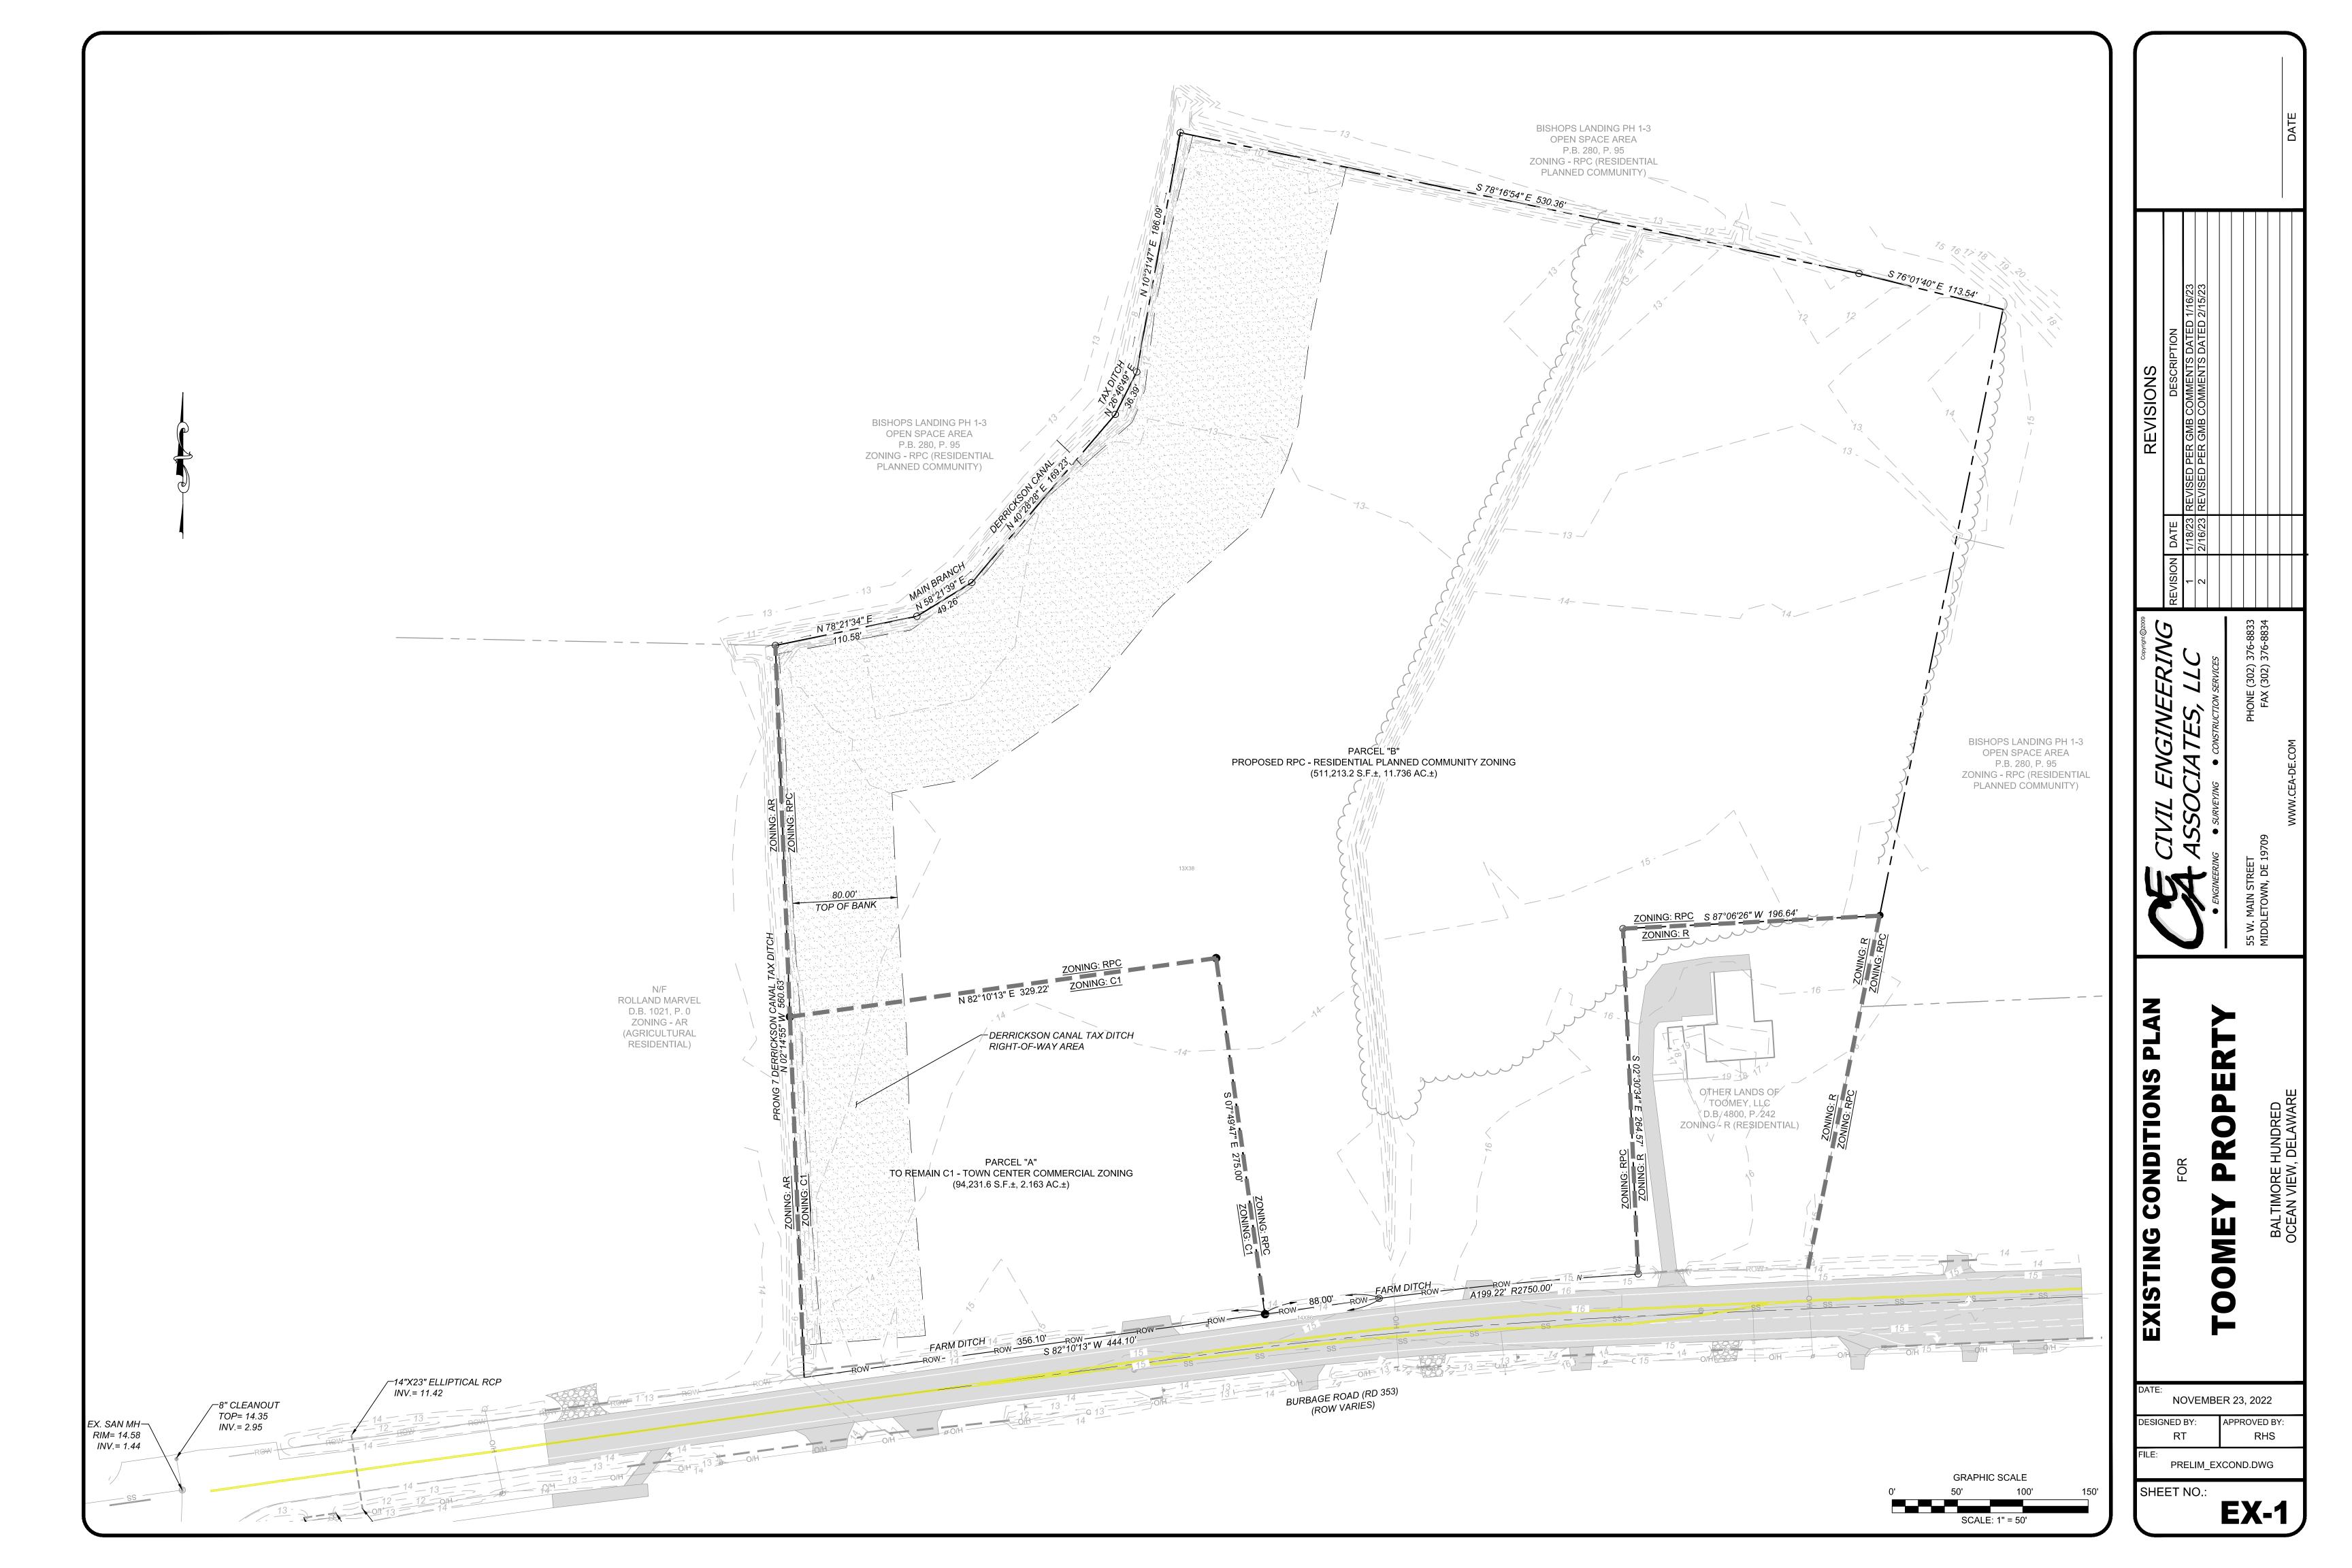
NOTES:

- 1. THE DEVELOPER IS RESPONSIBLE FOR CORRECTIVE MEASURES ASSOCIATED WITH SLOPES LESS THAN 0.5%. THE TOWN OF MILLVILLE WILL NOT BE RESPONSIBLE FOR ANY CORRECTIVE MEASURES.
- 2. ALL FILL MATERIAL WITHIN THE PROPOSED RIGHT OF WAY SHALL MEET TYPE F MATERIAL SPECIFICATIONS AS REQUIRED BY DELDOT. MATERIAL SHALL BE PLACED IN SUCCESSIVE LAYERS, AND EACH LAYER SHALL BE PLACED IN A LEVEL, UNIFORM CROSS-SECTION, NOT TO EXCEED 8" IN DEPTH, LOOSE MEASUREMENT, UNLESS OTHERWISE APPROVED BY THE ENGINEER. EACH LAYER SHALL BE PROPERLY COMPACTED, AS HEREINAFER SPECIFIED, BEFORE STARTING THE NEXT LAYER.
- 3. COMPACTION SHALL CONTINUE UNTIL EACH LAYER IS THOROUGHLY AND UNIFORMLY COMPACTED TO THE FULL WIDTH OF THE EMBANKMENT AND TO 95% OR MORE OF THE MAXIMUM DENSITY OF THE SAME SOILS AS DETERMINED BY AASHTO T99 METHOD C, MODIFIED. THE DETERMINATION OF COMPLIANCE WITH FIELD COMPACTION REQUIREMENTS, AS SPECIFIED HEREIN, SHALL BE IN ACCORDANCE WITH THE FOLLOWING AASHTO TEST METHODS:
 - (1) AASHTO T191, T238 AND T239, MODIFIED. FIELD DENSITY TESTS SHALL BE EXPRESSED AS A PERCENTAGE OF THE MAXIMUM DENSITY MADE ON THE SAME SOILS. (2) AASHTO T99 METHOD C, MODIFIED, DETERMINATION OF MAXIMUM DENSITY AND OPTIMUM MOISTURE CONTENT.
 - (3) AASHTO T224, MODIFIED, BY COARSE PARTICLE CORRECTION METHOD.
- 4. COMPACTION TESTING SHALL BE PERFORMED BY A QUALIFIED GEOTECHNICAL TESTING FIRM. ALL TESTING SHALL BE COMPLIANCE WITH CURRENT DELDOT REGULATIONS.

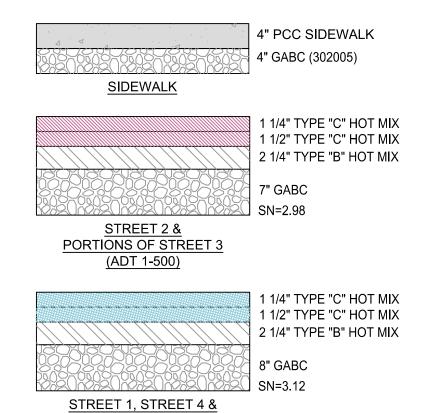

TYPICAL PAVEMENT SECTIONS

PORTIONS OF STREET 3 (ADT 501-1000)

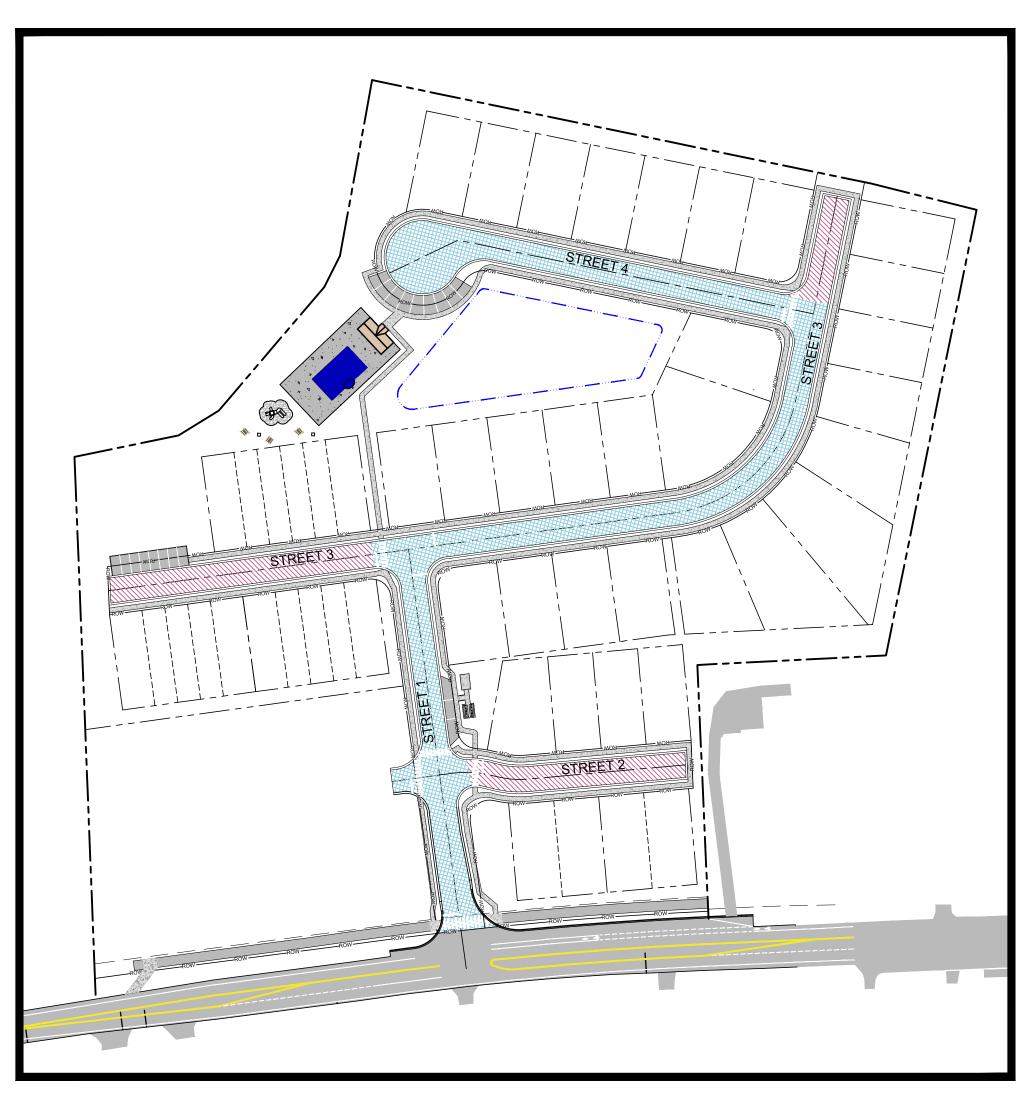


PAVEMENT SECTION KEY MAP SCALE: 1" = 150'

NOVEMBER 23, 2022 DESIGNED BY: APPROVED BY:


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SHEET NO.:

D-2




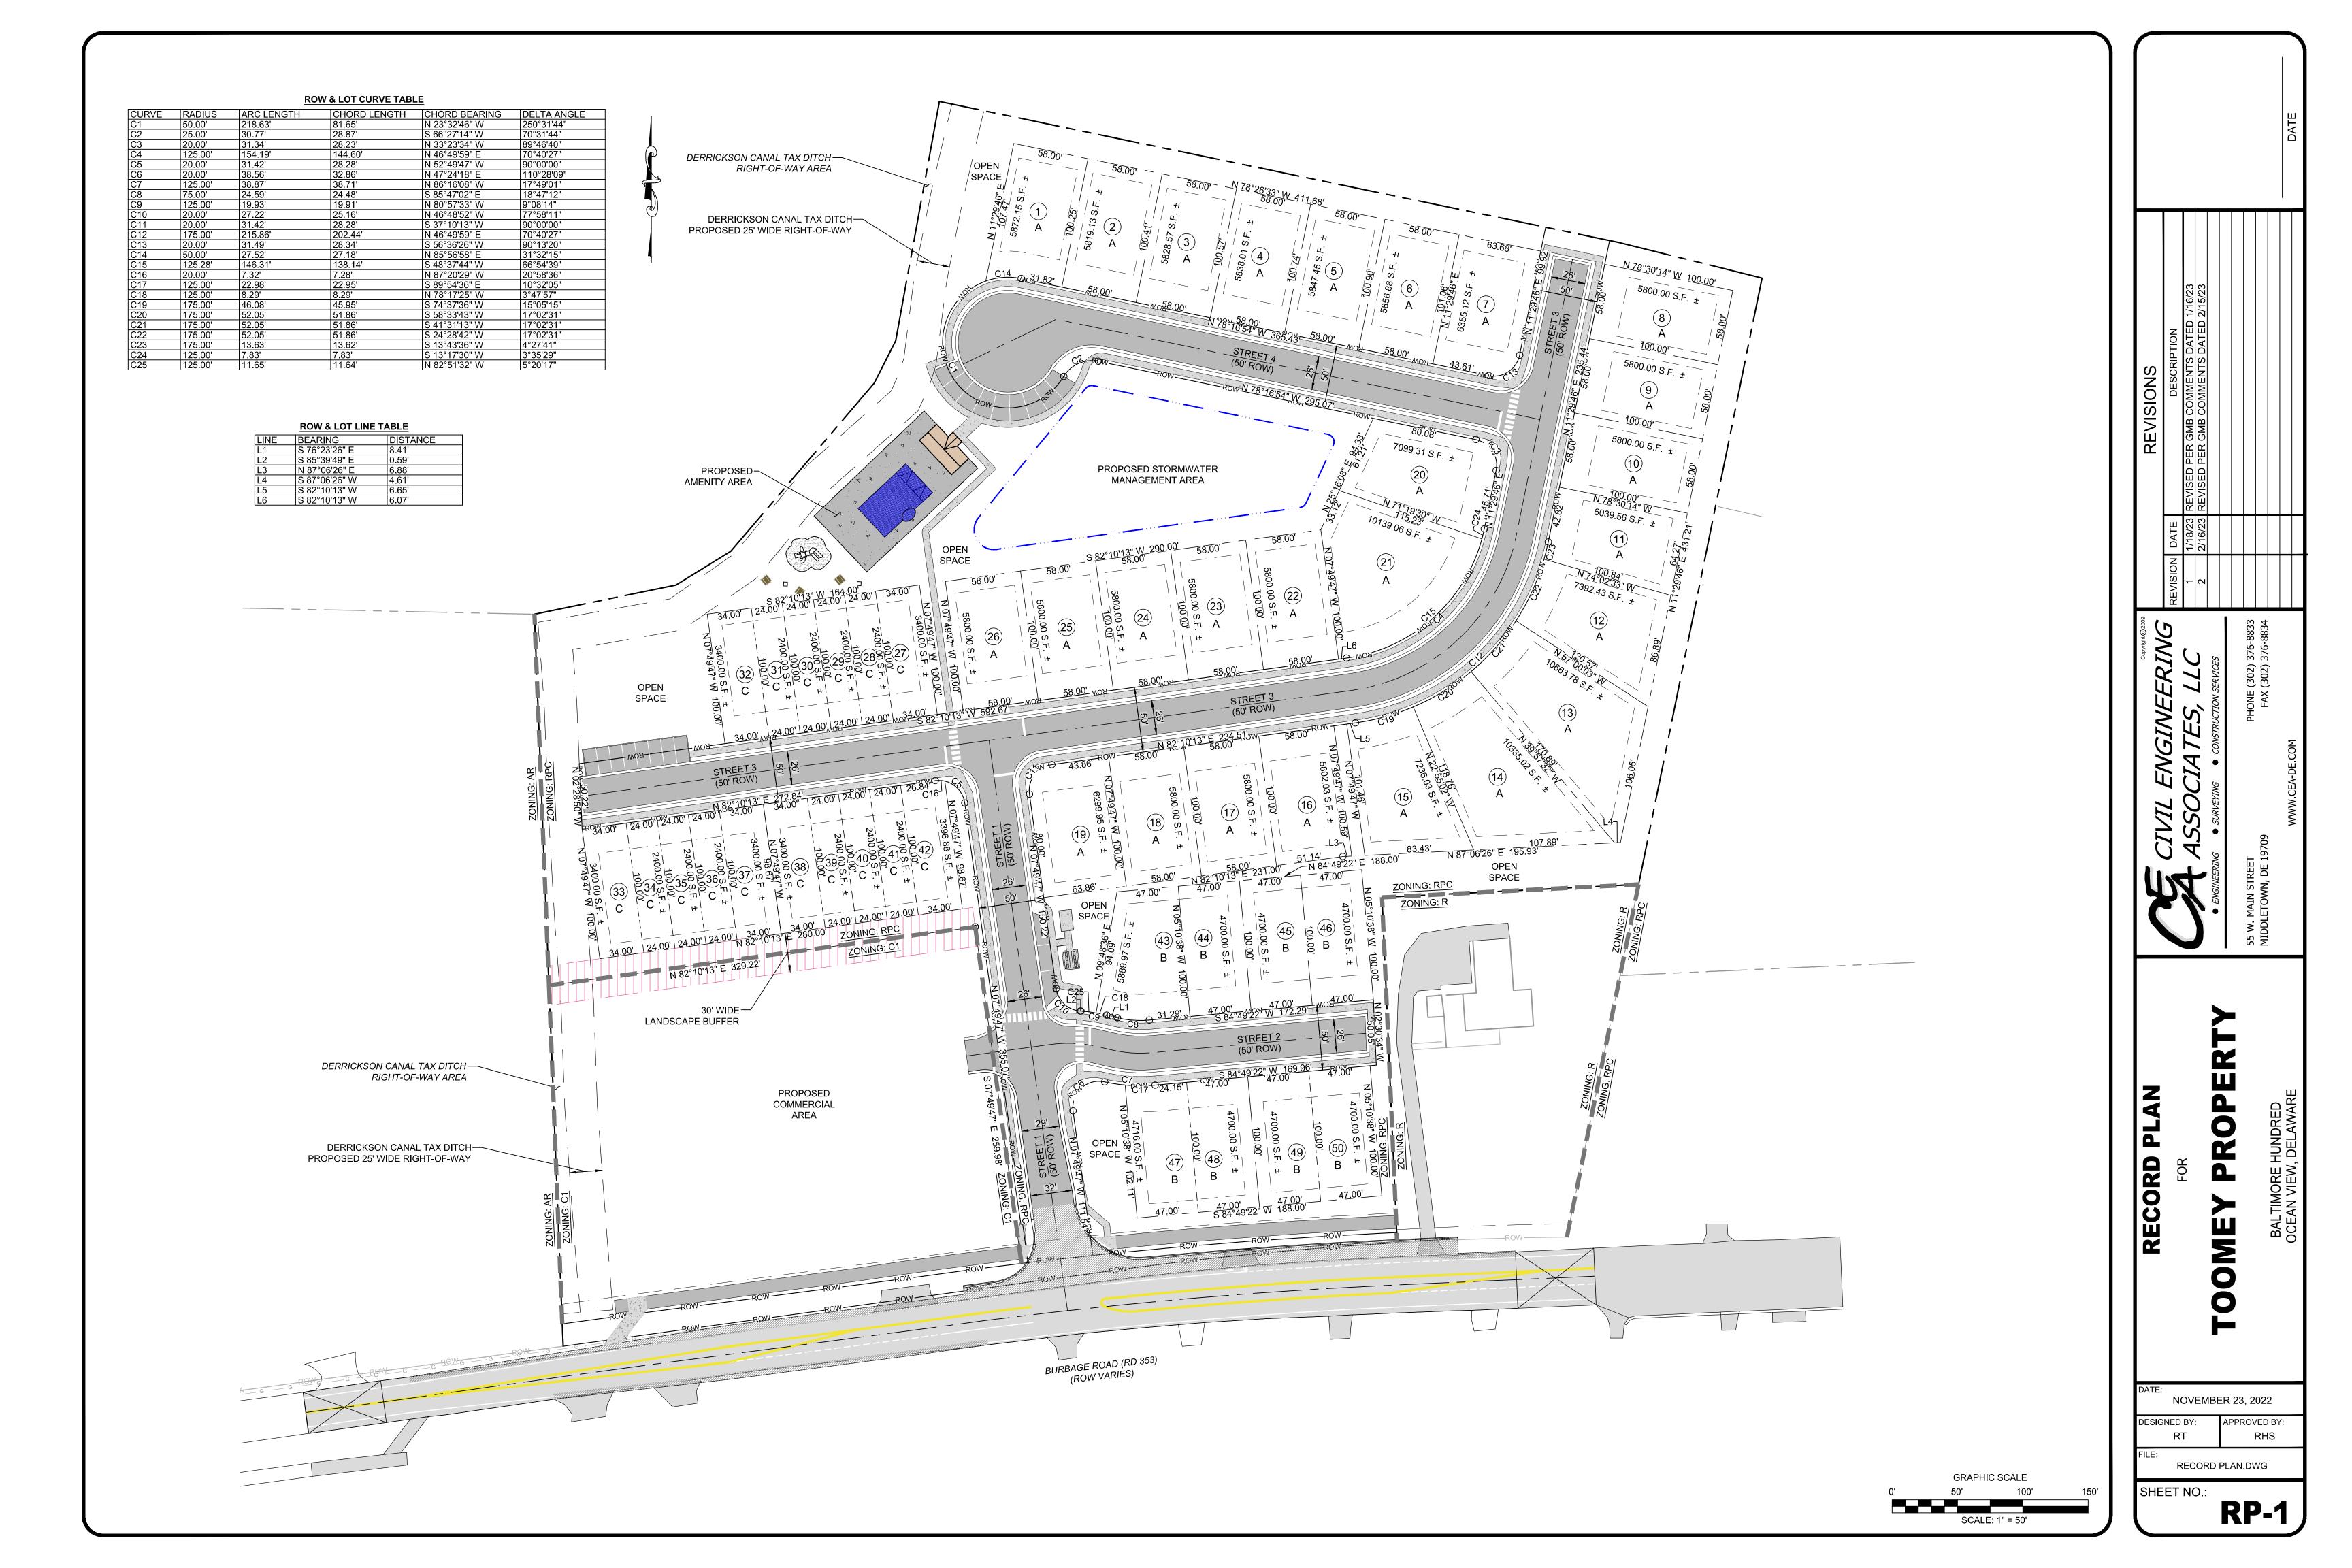

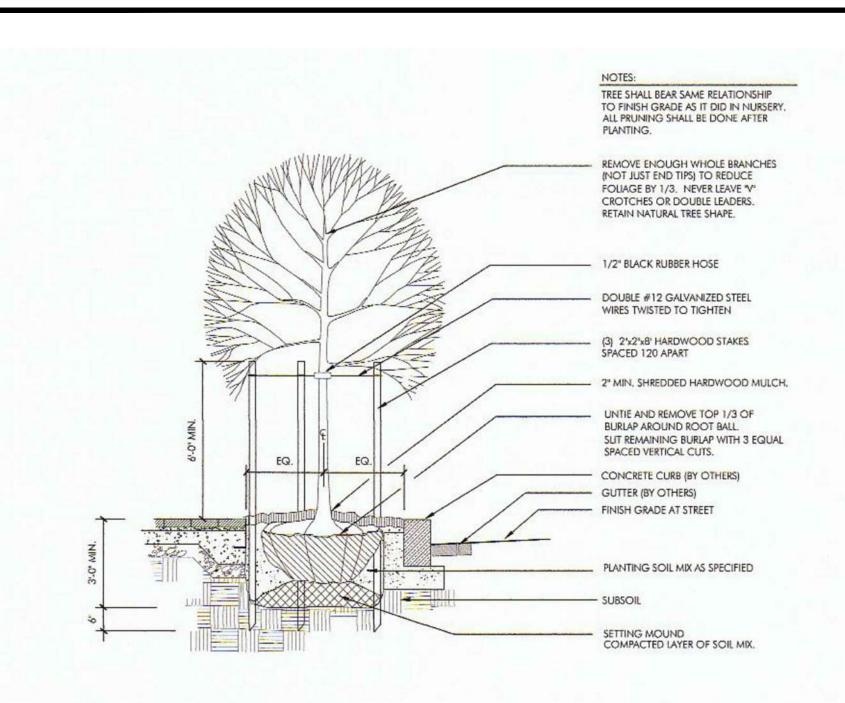


STREET TREE PLANTING

SCALE: NTS

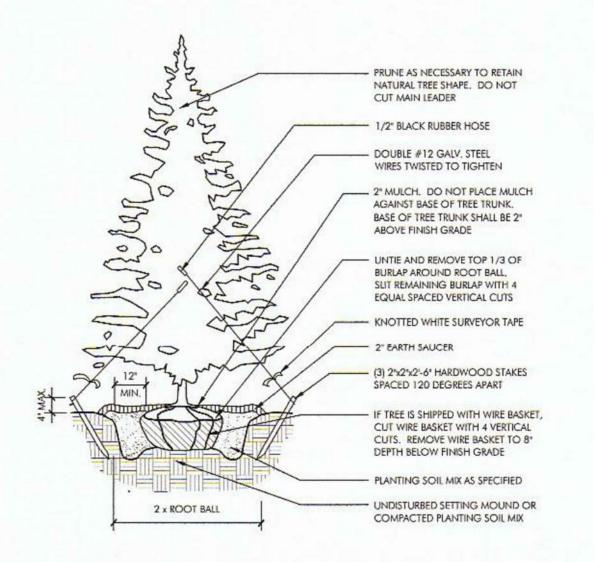

EVERGREEN TREE PLANTING

SCALE : NTS

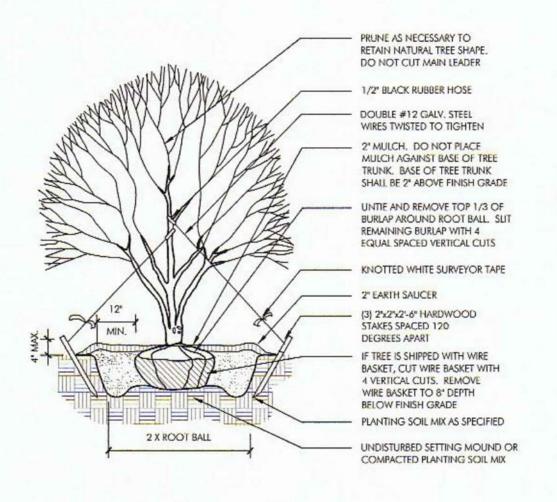

PLANT SPACING ROW 6° O.C. 5° O.C. 8° O.C. 7° O.C. 10° O.C. 9° O.C. 12" O.C. 10" O.C. 14" O.C. 12" O.C. 15° O.C. 13° O.C. 16° O.C. 14° O.C. 18" O.C. 16" O.C. 24" O.C. 21" O.C. GROUND COVERS AND PERENNIALS TO BE 30° O.C. 26° O.C. INSTALLED WITH TRIANGULAR SPACING 36" O.C. 30" O.C.

04 PLANT SPACING

SCALE: NTS

Plant Sch	hedule				1	
YTC	KEY	BOTANICAL NAME	COMMON NAME	SIZE	COND.	COMMENTS
Canopy	Trees				Rent of Rent	
	AR	Acer rubrum 'Red Sunsef	Red Sunset Red Maple	2-2 1/2" cal.	B&B	single leader; full branching
	AT	Asimina triloba	Pawpaw	2-2 1/2"	B&B	single leader; full branching
	BN	Betula nigra	River Birch	2-2 1/2" cal.	B&B	multi-stem; matched, full branching
	PA	Platanus x acerifolia 'Exclamation'	London Planetree	2-2 1/2" cal.	B&B	single leader; full branching
	QA	Quercus alba	White Oak	2-2 1/2" cal.	B&B	single leader; full branching
	QC	Quercus coccinea	Scarlet Oak	2-2 1/2" cal.	8&B	single leader; full branching
	QP	Quercus phellos	Willow Oak	2-2 1/2" cal.	B&B	single leader; full branching
vergree	n Trees				SECTION .	CALLES AND A DESCRIPTION OF THE PARTY OF THE
	PT	Pinus taeda	Loblolly Pine	12-14' ht.	8&B	heavy; matched; symmetrical
	PV	Pinus virginiana	Virginia Pine	12-14' ht.	B&B	heavy; matched; symmetrical
mame	ntal Tree	s				
	AM	Amelanchier canadensis	Allegheny Servicebeny	8'-10' ht.	B&B	multistem - 3 stems minimum; full branching
otes:						

PLANTING SCHEDULE

Society of Landscape Architects, the International Society of Arboriculture, and the American National Standards Institute.

ROPER

OME

NOVEMBER 23, 2022 APPROVED BY: DESIGNED BY:

RHS PRELIM_LANDSCAPE_PLAN.DWG

SHEET NO.:

MULTISTEM TREE PLANTING