
STANDARD WATER / WASTEWATER NOTES AND REQUIREMENTS


- 1. HYDRANT CONNECTIONS BY THE CONTRACTOR ARE PROHIBITED. THIS METHOD MAY NOT BE UTILIZED DURING ANY PHASE OF THE PROJECT.
- 2. THE SITE CONTRACTOR SHALL CONTACT THE TOWN OF MILLVILLE AT (302) 539-0449 PRIOR TO THE START OF CONSTRUCTION. A REPRESENTATIVE FROM THE TOWN OF MILLVILLE PUBLIC UTILITIES DEPARTMENT MUST OBSERVE AND APPROVE ALL WATER AND SANITARY SEWER INTERCONNECTIONS AND TESTING. ALL WATER TAPS AND SANITARY SEWER CONNECTIONS MUST BE PERFORMED BY A TOWN OF MILLVILLE APPROVED CONTRACTOR. THE PROPOSED LOCATION FOR THE CONNECTION MAY NEED TO BE ADJUSTED IN THE FIELD DUE TO CONDITIONS OF THE EXISTING MAIN. POSSIBLE CONDITIONS THAT WOULD REQUIRE TAPPING / CONNECTION RELOCATION INCLUDE PROXIMITY TO PIPE JOINTS, OTHER TAPS, CONCRETE ENCASEMENT: CONFLICT WITH OTHER UTILITIES, AND THE LIKE. TEST HOLES MUST BE PERFORMED BY THE CONTRACTOR TO DETERMINE THE BEST TAPPING / CONNECTION LOCATION. OR FOR ANY WORK PEOULIED BY THE CONTRACTOR TO MAKE AN APPROPRIATE AND LAWFULL CONNECTION.
- 3. ALL WATER AND WASTEWATER UTILITY CONSTRUCTION AND MATERIALS SHALL MEET ALL TOWN OF MILLVILLE STANDARDS AND SPECIFICATIONS AS AS CURRENT REQUIREMENTS AND PRACTICES.
- 4. ALL EXISTING UTILITIES SHALL BE FIFLD VERIFIED PRIOR TO THE START OF CONSTRUCTION
- 5. ALL EXISTING UTILITIES SHALL BE ADJUSTED TO GRADE, AND REPAIRED OR REPLACED WHEN DEEMED NECESSARY BY THE PUBLIC UTILITIES DEPARTMENT. IN ALL AREAS OF DISTURBANCE ASSOCIATED WITH CONSTRUCTION.
- 6. ANY EXISTING WATER OR WASTEWATER UTILITY LINES NOT TO BE UTILIZED BY THE PROPOSED PROJECT SHALL BE PROPERLY ABANDONED AT THE MAINS, IN ACCORDANCE WITH THE TOWN OF MILLVILLE DEPARTMENT OF PUBLIC WORKS SPECIFICATIONS AND REQUIREMENTS, BY THE DEVELOPER OWNER.
- 7. ALL NON-METALLIC WATER LINES (MAINS AND SERVICES) SHALL BE INSTALLED WITH A TRACER WIRE AND IDENTIFICATION TAPE. THE WIRE SHALL BE A MINIMUM OF TWELVE (12) GAUGE BLUE COATED SOLID COPPER WIRE, WRAPPED AROUND THE PIPE, AND EXTENDING UP INTO ALL VALVE AND CURB BOXES. THE IDENTIFICATION TAPE SHALL BE SIX-INCHES (6") WIDE, LAID ONE FOOT (1') ABOVE THE PIPE, WITH THE FOLLOWING TEXT: "CAUTION: BURIED WATER LINE BELOW".
- 8. ALL NON-METALLIC WASTEWATER LINES (MAINS AND LATERALS) SHALL BE INSTALLED WITH A TRACER WIRE AND IDENTIFICATION TAPE. (TRACER WIRE IS NOT REQUIRED ON GRAVITY MAINS.) THE WIRE SHALL BE A MINIMUM OF TWELVE (12) GAUGE GREEN COATED SOLID COPPER WIRE, WRAPPED AROUND THE PIPE. THE IDENTIFICATION DETECTOR TAPE SHALL BE SIX-INCHES (6") WIDE, LAID ONE FOOT (1') ABOVE THE PIPE, WITH THE FOLLOWING TEXT: "CAUTION: BURIED SEWER LINE BELOW".
- 9. NO TREES MAY BE PLANTED WITHIN TEN FEET (10') OF WATER AND WASTEWATER UTILITY INFRASTRUCTURE.
- 10. NO STRUCTURES, INCLUDING PERMANENT SIGNAGE, MAY BE LOCATED WITHIN TEN FEET (10') OF WATER AND WASTEWATER UTILITY INFRASTRUCTURE.
- 11. WATER AND WASTEWATER LINES MAY NOT BE LOCATED NEAR ANY POTENTIAL SOURCE OF CONTAMINATION.
- ANY EXISTING SANITARY SEWER LINES NOT TO BE UTILIZED BY THE PROPOSED FACILITY MUST BE PROPERLY ABANDONED AT THE MAINS IN ACCORDANCE WITH THE TOWN OF MILLVILLE DEPARTMENT OF PUBLIC WORKS SPECIFICATIONS AND REQUIREMENTS.


SITE CONSTRUCTION PLANS FOR


MILLVILLE PROFESSIONAL SERVICES OFFICE

134-12.00-342.00, 35136 ATLANTIC AVE TOWN OF MILLVILLE, SUSSEX COUNTY, DELAWARE

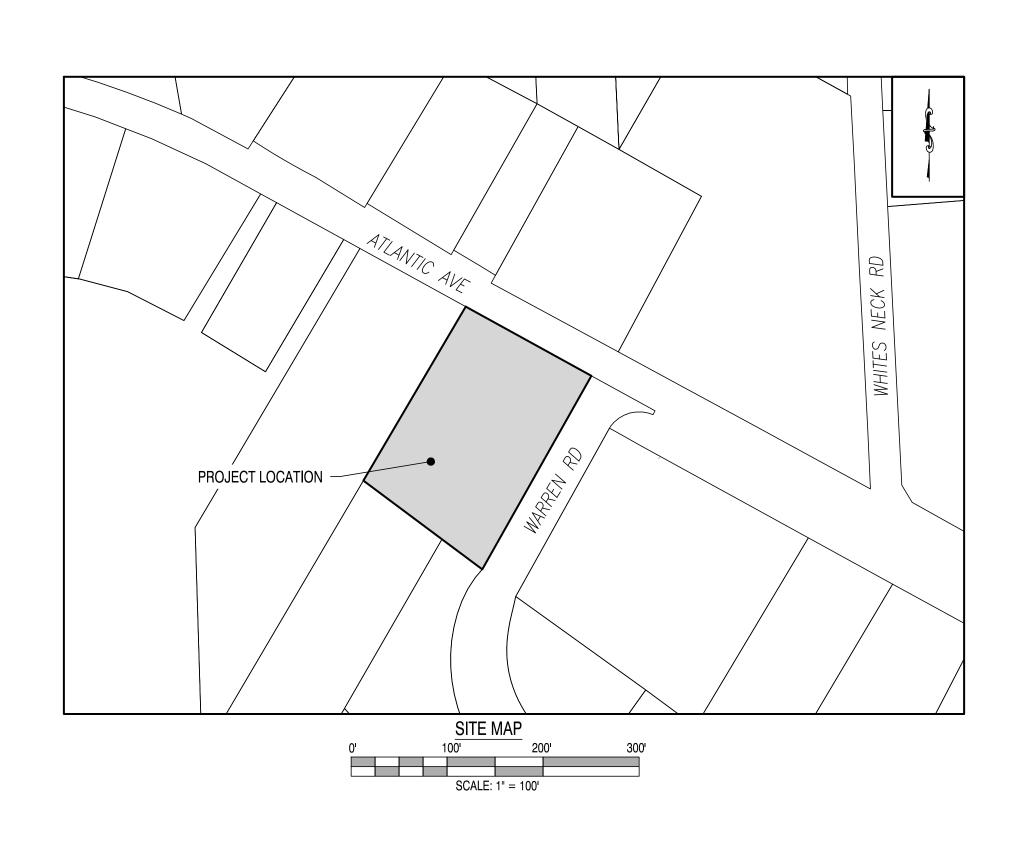

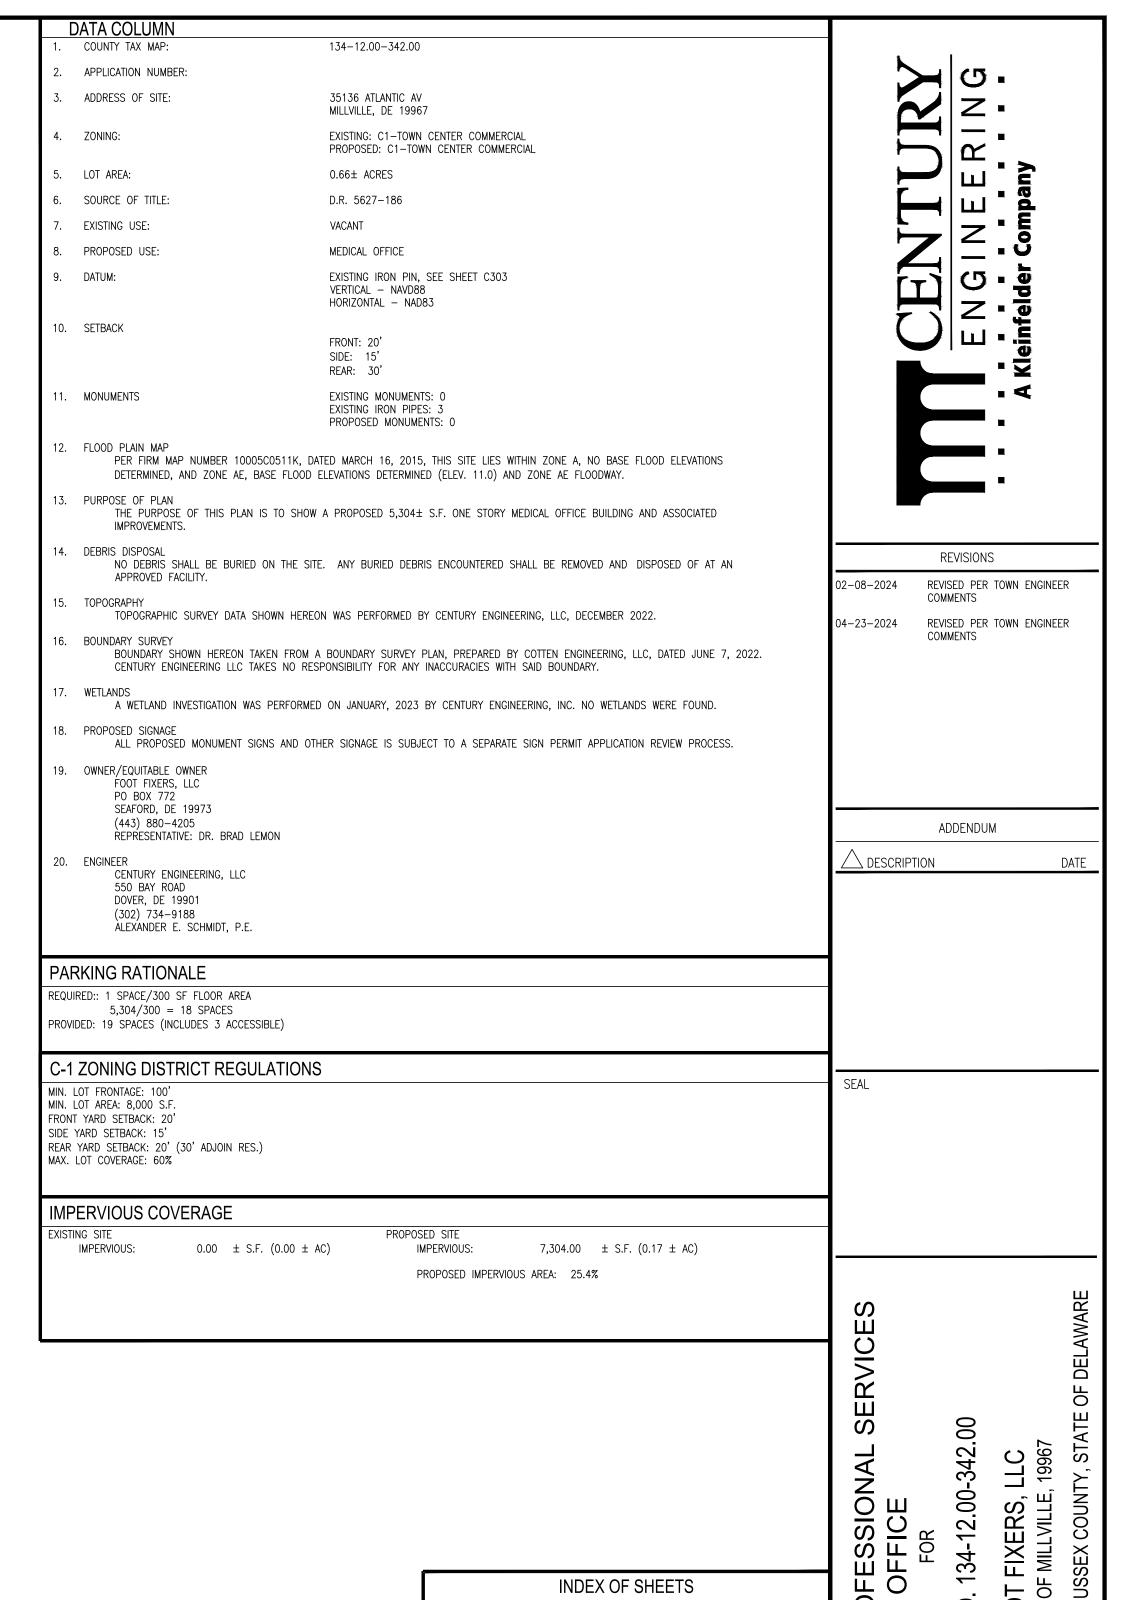

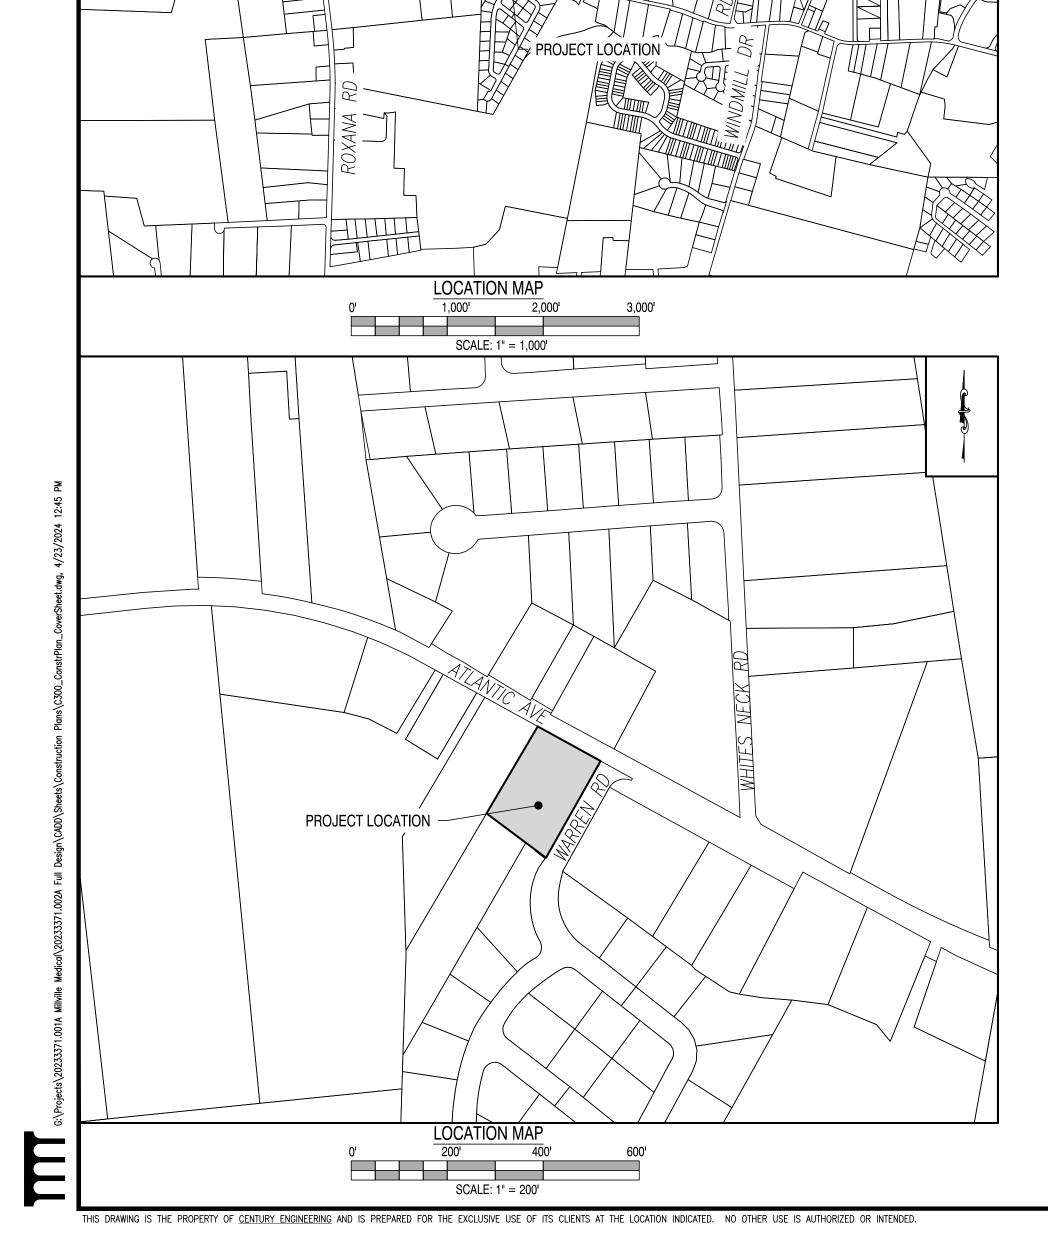

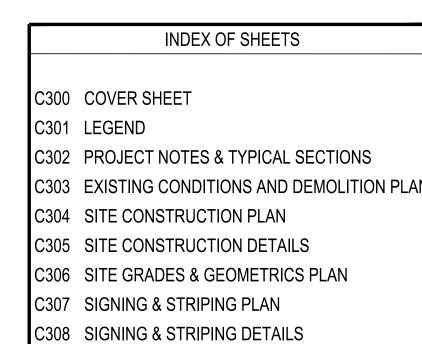

C309 ROAD PROFILES

C310 FIRE MARSHAL PLAN

C311 SITE LIGHTING PLAN

C312 LANDSCAPE PLAN

C313 LANDSCAPE DETAILS

COVER SHEET
TOWN OF MILLVILL

SHEET TITLE

CERTIFICATION OF PLAN ACCURACY	
I, ALEXANDER E. SCHMIDT, HEREBY CERTIFY THAT I AM A REGISTERED PROFESSION. THE STATE OF DELAWARE, THAT THE INFORMATION SHOWN HEREON HAS BEEN PLAY SUPERVISION AND TO THE BEST OF MY KNOWLEDGE AND BELIEF REPRESENT ENGINEERING PRACTICES AS REQUIRED BY THE APPLICABLE LAWS OF THE STATE	REPARED UNDER S GOOD
Mas Samuel	4/23/2024
ALEXANDER E. SCHMIDT, P.E., DE NO. 16139	DATE

CENTURY ENGINEERING, LLC

DOVER, DELAWARE 19901

(302) 734-9188

I, DR. BRAD LEMON, HEREBY CERTIFY THAT I AM THE OWNER OF THE PROPERTY DESCRIBED AND SHOWN ON THIS PLAN, THAT THE PLAN WAS MADE AT MY DIRECTION, AND THAT I ACKNOWLEDGE THE SAME TO ME BY ACT AND DESIRE THE PLAN TO BE DEVELOPED AS SHOWN IN ACCORDANCE WITH ALL APPLICABLE LAWS AND REGULATIONS.

DR. BRAD LEMON
FOOT FIXERS, LLC
PO BOX 772
SEAFORD, DE 19973
(443) 880-4205

TOWN OF MILLVILLE
SUBMISSION
AUGUST 2023

TCV AES/DLD

SCALE SHEET NO.

AS NOTED PROJECT NO.

20233371.002A

DRAINAGE FEATURES			
FEATURE DESCRIPTION	EXISTING	PROPOSED	ID
BIOFILTRATION SWALE		—← BFS—►X—	
DITCH OR STREAM CENTERLINE		_xx	
DIRECTIONAL STREAM FLOW ARROW			
DRAINAGE INLET	C.B.		DIX
DRAINAGE JUNCTION BOX	J.B.		JB X
DRAINAGE MANHOLE	0	•	MH
DRAINAGE PIPE AND FLOW ARROW	SIZE TYPE		PX
FLARED END SECTION			FES
RIPRAP – AREA FEATURE		505050	RRX
SAFETY END SECTION			SES X
UNDERDRAIN			UD X
UNDERDRAIN OUTLET			UDO X

GRADII	NG	
FEATURE DESCRIPTION	EXISTING	PROPOSED
CONTOUR		
SPOT ELEVATIONS	O XX.XX	O

UTILITY FE	ATURES	
FEATURE DESCRIPTION	EXISTING	PROPOSED
CABLE TV DISTRIBUTION BOX	TV	
COMMUNICATIONS — UNDERGROUND	—— СОММ ———	сомм
ELECTRIC — UNDERGROUND	———— UG-E	——— UG-E
ELECTRIC MANHOLE	Ē	
ELECTRIC METER	E.M.	
ELECTRIC TRANSFORMER	E.T.	
GAS – UNDERGROUND	UG-G	UG-G
GAS MANHOLE	©	
GAS METER	G.M.	
GAS VALVE	G.V.	
GAS PUMP - SERVICE STATION	G.P.	
IRRIGATION — UNDERGROUND	IRIR	—— IR ——— IR ——
ITMS — UNDERGROUND	ITMS	ITMS
KNOX BOX		
LIGHTING — UNDERGROUND	— LI — LI —	uu
LUMINAIRE — POLE MOUNTED		
MANHOLE — UNDETERMINED OWNER	MH	
RAILROAD TRACKS		
SANITARY — UNDERGROUND	— S— S— S—	<u>= s== s== s=</u>
SANITARY SEWER MANHOLE	(\$)	•
SANITARY SEWER VALVE	S.V.	S.V.
SANITARY SEWER CLEANOUT OR VENT	CO	CO ©
SEPTIC DRAIN FIELD	S.D.F.	
SIGNALIZATION — UNDERGROUND	SIG	SIG
SOIL BORING LOCATION	_	SIG
SOIL BORING LOCATION	•	——————————————————————————————————————
	В	——————————————————————————————————————
SOIL BORING LOCATION TELEPHONE BOOTH TELEPHONE MANHOLE	•	——————————————————————————————————————
SOIL BORING LOCATION TELEPHONE BOOTH TELEPHONE MANHOLE TELEPHONE TEST POINT	B TIP	——————————————————————————————————————
SOIL BORING LOCATION TELEPHONE BOOTH TELEPHONE MANHOLE TELEPHONE TEST POINT TRAFFIC — CONDUIT JUNCTION WELL	B TIP J.W.	——————————————————————————————————————
SOIL BORING LOCATION TELEPHONE BOOTH TELEPHONE MANHOLE TELEPHONE TEST POINT TRAFFIC — CONDUIT JUNCTION WELL TRAFFIC — LIGHT POLE AND BASE	B TTP O J.W.	SIG
SOIL BORING LOCATION TELEPHONE BOOTH TELEPHONE MANHOLE TELEPHONE TEST POINT TRAFFIC — CONDUIT JUNCTION WELL TRAFFIC — LIGHT POLE AND BASE TRAFFIC — PEDESTRIAN POLE & BASE	B T TIP J.W.	——————————————————————————————————————
SOIL BORING LOCATION TELEPHONE BOOTH TELEPHONE MANHOLE TELEPHONE TEST POINT TRAFFIC — CONDUIT JUNCTION WELL TRAFFIC — LIGHT POLE AND BASE TRAFFIC — PEDESTRIAN POLE & BASE TRAFFIC — SIGNAL CABINET & BASE	B ID ITP O J.W. O O O O O O O O O O O O O	
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SOIL BORING LOCATION TELEPHONE BOOTH TELEPHONE MANHOLE TELEPHONE TEST POINT TRAFFIC — CONDUIT JUNCTION WELL TRAFFIC — LIGHT POLE AND BASE TRAFFIC — PEDESTRIAN POLE & BASE TRAFFIC — SIGNAL CABINET & BASE UNKNOWN UTILITY — UNDERGROUND	B ITP J.W. S UG-UK	SIG
SOIL BORING LOCATION TELEPHONE BOOTH TELEPHONE MANHOLE TELEPHONE TEST POINT TRAFFIC - CONDUIT JUNCTION WELL TRAFFIC - LIGHT POLE AND BASE TRAFFIC - PEDESTRIAN POLE & BASE TRAFFIC - SIGNAL CABINET & BASE TRAFFIC - SIGNAL POLE AND BASE UNKNOWN UTILITY - UNDERGROUND UTILITY BOX	B ITP J.W. IIP O J.W. III J.W. III J.W. III J.W. III J.W. J.	—————————————————————————————————————
SOIL BORING LOCATION TELEPHONE BOOTH TELEPHONE MANHOLE TELEPHONE TEST POINT TRAFFIC - CONDUIT JUNCTION WELL TRAFFIC - LIGHT POLE AND BASE TRAFFIC - PEDESTRIAN POLE & BASE TRAFFIC - SIGNAL CABINET & BASE TRAFFIC - SIGNAL POLE AND BASE UNKNOWN UTILITY - UNDERGROUND UTILITY BOX UTILITY POLE GUY WIRE ANCHOR	B ITP J.W. IDP O J.W. IDP O W. IDP O W. IDP O W. IDP W. IDP W. IDP W. IDP W. IDP W. IDP W. W. IDP W. W. IDP W.	
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SOIL BORING LOCATION TELEPHONE BOOTH TELEPHONE MANHOLE TELEPHONE TEST POINT TRAFFIC - CONDUIT JUNCTION WELL TRAFFIC - LIGHT POLE AND BASE TRAFFIC - PEDESTRIAN POLE & BASE TRAFFIC - SIGNAL CABINET & BASE TRAFFIC - SIGNAL POLE AND BASE UNKNOWN UTILITY - UNDERGROUND UTILITY BOX UTILITY POLE GUY WIRE ANCHOR UTILITY POLE UTILITY TEST HOLE LOCATION WALL PACK - LIGHTING WATER - UNDERGROUND	B B T T T F O J.W.	●→ W.P. W.P.
SOIL BORING LOCATION TELEPHONE BOOTH TELEPHONE MANHOLE TELEPHONE TEST POINT TRAFFIC - CONDUIT JUNCTION WELL TRAFFIC - LIGHT POLE AND BASE TRAFFIC - PEDESTRIAN POLE & BASE TRAFFIC - SIGNAL CABINET & BASE TRAFFIC - SIGNAL POLE AND BASE UNKNOWN UTILITY - UNDERGROUND UTILITY BOX UTILITY POLE GUY WIRE ANCHOR UTILITY POLE UTILITY TEST HOLE LOCATION WALL PACK - LIGHTING WATER - UNDERGROUND	B B	
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PAVEMENT SECTION(S)	
MILL AND OVERLAY — SEE TYPICAL SECTIONS FOR MATERIAL AND DEPTHS	
FULL DEPTH PAVEMENT	
SHARED USE PATH	
GRAVEL	
PENGRABEE PAVEMENT	A A A

NATURAL ROADSIDE FEATURES		
FEATURE DESCRIPTION	EXISTING	PROPOSED
HEDGEROW OR THICKET		
MARSH BOUNDARY LINE		
TREE - CONIFEROUS	*	
TREE - DECIDUOUS	\otimes	
TREE STUMP	Д	
SHRUBBERY	\$	
WETLAND BOUNDARY — DELINEATED		
WOODS LINE BOUNDARY		~~~~
FLOODPLAIN	FP	

RIGHT-OF-WAY FEATURES		
FEATURE DESCRIPTION	EXISTING	PROPOSED
DENIAL OF ACCESS	——— DA ———	DA
EASEMENT - OTHERS		
PERMANENT EASEMENT	——————————————————————————————————————	PE
PROPERTY LINE		
PROPERTY MARKER — CONCRETE	CM	C. <u>M</u> .
PROPERTY MARKER - IRON PIPE	I.P.	I.P.
RIGHT-OF-WAY BASELINE	100+00	100+00
RIGHT-OF-WAY LINE	RW	RW
RIGHT-OF-WAY & DENIAL OF ACCESS	R/W-DA	R/W-DA
RIGHT-TO-ENTER		RTE
TEMPORARY CONSTRUCTION EASEMENT		TCE
CLEAR ZONE		cz
HORIZONTAL CLEARANCE		——— НС ———

EXISTING

MISCELLANEOUS FEATURES		
FEATURE DESCRIPTION	PROPOSED	
BUTT JOINT		
CLEAR ZONE	cz	
CONSTRUCTION BASELINE	100+00	
LIMIT OF CONSTRUCTION	LOC	
DEMOLITION		
P.C.C. SIDEWALK	A	
6" P.C.C. SIDEWALK		
PAVEMENT PATCH		
ACCESSIBLE RAMP	ويم	
SAMO ICUPLAIN	SAW	

SURVEY CONTROL & MONUMENTATION

FEATURE DESCRIPTION

SURVEY BENCHMARK LOCATION

SURVEY TIE POINT LOCATION

SURVEY TRAVERSE POINT

EROSION & SEDIMENT CONTROL FEATURES	
FEATURE DESCRIPTION PROPOSED	
LIMIT OF DISTURBANCE	LOD
PORTABLE SEDIMENT TANK	ST
PUMPING PIT	PP-2
SILT FENCE	SF
COMPOST FILTER LOG	———— CFL ————
SENSITIVE AREA PROTECTION	SAP

FEATURE DESCRIPTION	ID
ABANDON BY CONTRACTOR	(AB) C
ABANDON BY OTHERS	AB
ADJUST BY CONTRACTOR	A C
ADJUST BY OTHERS	A
BEST MANAGEMENT PRACTICE	BMP
BUS STOP PAD / TYPE	BSP
BUS STOP WITH SHELTER PAD / TYPE	BSSP
CONCRETE SAFETY BARRIER	B XX
CONVERT TO JUNCTION BOX	CJB XX
CONVERT TO DRAINAGE MANHOLE	CDM
DO NOT DISTURB	DND
ENERGY DISSIPATOR	ED XX
FILL WITH FLOWABLE FILL	FF C
LANDSCAPE PLANTINGS	LS
PEDESTRIAN CONNECTION / TYPE	PC XX
RELOCATE BY CONTRACTOR	RL C
RELOCATE BY OTHERS	RL O
RELOCATE BY PROPERTY OWNER	RL
REMOVE BY CONTRACTOR	RMC
REMOVE BY OTHERS	RMO
REMOVE BY TRAFFIC CONTRACTOR	RM TC
RIGHT-OF-WAY MONUMENT	RM

	ABBREVIATION SCHEDULE
BREVIATION A	DEFINITION AMERICANS WITH DISABILITIES ACT
LOW.	ALLOWABLE
D UM	ALLOWABLE STRESS DESIGN ALUMINUM
UM	BASE LINE
П	BOTTOM
<u>G</u> P	BEARING CAPACITY
	CONTROL JOINT
	CENTER LINE
R NC	CLEAR CONCRETE
NN	CONNECTION
<u>rr</u> J	CORRUGATED CONSTRUTION JOINT
<u></u> М	DIVISION OF FACILITIES MANAGEMENT
ιG	DIAGONAL
REC	DEAD LOAD DEPARTMENT OF NATURAL RESOURCES AND ENVIRONMENTAL CONTRO
L	DEPARTMENT OF LABOR
T -	DEPARTMENT OF TRANSPORTATION
., ELEV	EACH FACE ELEVATION
Ü.	EQUAL
EXIST.	EXISTING
.	FAR FACE COMPRESSIVE STRENGH OF CONCRETE
l. FL.	FINISHED FLOOR
l. GR.	FINISHED GRADE
<u>D</u> G	FOUNDATION FOOTING
,	YIELD STRENGTH OF STEEL
BC	GRADED AGGREGATE BASE COURSE
LV RIZ	GALVANIZED HORIZONTAL
	JOINT
	KIPS PER SQUARE INCH LIVE LOAD
/	LONG LEG VERTICAL
1	LONG LEG HORIZONTAL
BB C	LONG LEG BACK TO BACK LIMIT OF CONSTRUCTION
D	LIMIT OF DISTURBANCE
FD	LOAD RESISTANCE FACTORED DESIGN
W L	MEAN HIGH WATER METAL
	NUMBER
<u>M</u> 	NOMINAL NEAR FACE
<u>. </u>	ON CENTER
W	ORDINARY HIGH WATER
<u>P</u> 	OPPOSITE PROPERTY LINE
.•	PLATE
	POUNDS PER SQUARE INCH
BAR	PRESSURE TREATED REINFORCING BAR
W, RW, R/W	RIGHT OF WAY
	SILT FENCE
<u>И</u> ВВ	SIMILAR SHORT LEG BACK TO BACK
טט	STAINLESS STEEL
4	STATION
) -	STANDARD STEEL
- ?	STRAIGHT
В	TOP AND BOTTOM
MW	TYPICAL ULTRA HIGH MOLECULAR WEIGHT
IF	UNIFORM
0	UNLESS NOTED OTHERWISE
rt E	VERTICAL WATER SURFACE ELEVATION
/F	WELDED WIRE FABRIC

GENERAL NOTE:

ALL ITEMS SHOWN MAY NOT BE PRESENT ON ALL SHEETS, OR PART OF THIS PROJECT.

NOT TO SCALE
PROJECT NO.
20233371.002A

SHEET TITLE

LEGEND


TOWN OF MILLVILLE


CHK'D/DESIGNER

SHEET NO.

AES/DLD


SUBMISSION AUGUST 2023

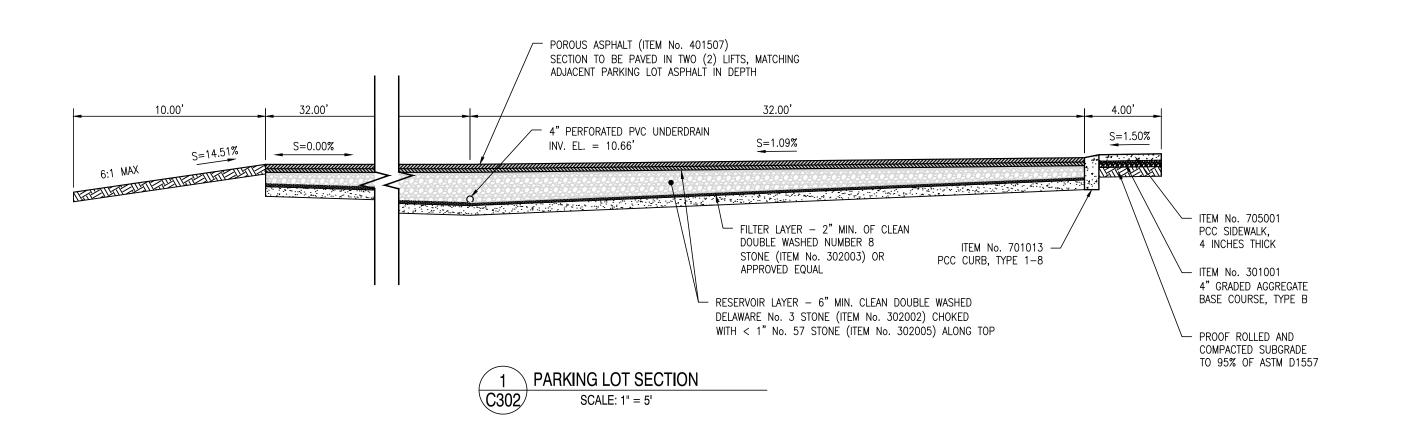

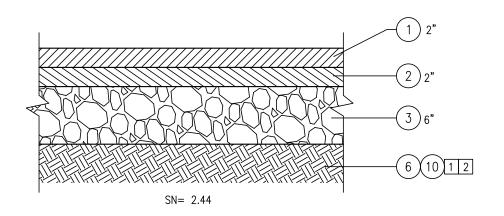

1. BORROW, TYPE C, SHALL BE UTILIZED FOR ALL PIPE TRENCH

2. BORROW, TYPE F, SHALL BE UTILIZED FOR FIRST 1' OF BACKFILL BENEATH PARKING LOT. ON—SITE MATERIAL MAY BE UTILIZED FOR ANY ADDITIONAL BACK FILL REQUIRED UNDER

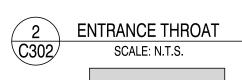

ALL SITE WORK AND MATERIALS REFERENCED IN THIS PLAN, INCLUDING BUT NOT LIMITED

TO, CURBS, PAVING, SIDEWALK, AND PARKING BUMPERS, SHALL FOLLOW DELDOT STANDARDS AND SPECIFICATIONS, UNLESS SPECIFICALLY NOTED ON THIS PLAN. SPECIFICATIONS REFERENCED IN THIS PLAN CAN BE FOUND IN THE DELDOT STANDARD SPECIFICATIONS FOR

BURIAL OF ORGANIC MATERIAL IS NOT PERMITTED. OPEN BURNING OF DOWNED TREES AND STUMPS IS NOT PERMITTED. CHIPPED MATERIALS MUST BE REMOVED PRIOR TO THE

THIS PROJECT IS COVERED UNDER A NPDES GENERAL PERMIT FOR CONSTRUCTION. THE

CONTRACTOR SHALL MAINTAIN A COPY OF THIS PERMIT ON THE JOB SITE, ALONG WITH A

THE CONTRACTOR MAY ELECT TO USE ANY OF THE FOLLOWING MATERIALS TO MEET THE

III. HOT-MIX MILLINGS (PER SPECIAL PROVISION 302514 - MILLED HOT-MIX BASE

THE CONTRACTOR WILL NOT BE ALLOWED TO MIX DIFFERENT MATERIALS OR SIMILAR MATERIALS FROM DIFFERENT SOURCES TO MEET THE REQUIREMENTS OF GRADED

ELEVATIONS GIVEN FOR DRAINAGE STRUCTURES ARE TO BE APPLIED TO THE CENTER OF THE GRATE FOR INLETS. INLETS THAT ARE LOCATED ALONG A CURB SHALL HAVE THE GRATE ELEVATION MATCH THE PROPOSED CURBLINE ELEVATION. ELEVATION DATA FOR MANHOLES IS GIVEN TO THE CENTER OF THE LID. ELEVATION DATA FOR JUNCTION BOXES

DRAINAGE INLET INVERTS ARE GIVEN TO THE LOWEST PIPE INVERT IN THE INLET. THE PIPE

ALL CHAIN LINK FENCING SHALL BE 8' TALL, 9 GAUGE STEEL. 8' TALL FENCE SLATS

. EXCESS SOIL SHALL BE RESPREAD ON SITE. THE LOCATION FOR RESPREAD OF ANY

MATERIAL IN EXCESS OF WHAT IS REQUIRED TO MEET THE FINAL GRADES SHOWN ON THIS PLAN SHALL BE CONFIRMED WITH THE OWNER PRIOR TO PLACING ANY TOPSOIL AND/OR RESPREADING ANY EXCESS MATERIAL. FOR PURPOSES OF BIDDING, THE CONTRACTOR SHALL ASSUME ALL EXCESS MATERIAL WILL BE RESPREAD ON THE OPEN AREAS EAST OF

THICKNESS SHALL BE TAKEN INTO ACCOUNT WHEN THE INLETS ARE PRECAST.

COPY OF THE APPROVED EROSION AND SEDIMENT CONTROL PLAN, AT ALL TIMES.

II. CRUSHED CONCRETE (PER STANDARD SPECIFICATION 821)

REQUIREMENTS OF GRADED AGGREGATE BASE COURSE, TYPE "B": I. CRUSHED STONE (PER STANDARD SPECIFICATION 821)

1) TYPE C BITUMINOUS CONCRETE, PG 64-22 CARBONATE STONE, (ITEM NO. 401005)

TYPE B BITUMINOUS CONCRETE, PG 64-22, (ITEM NO. 401014) (3) GRADED AGGREGATE BASE COURSE, TYPE B, (ITEM NO. 301003) [SEE PROJECT NOTE 4]

(4) BORROW, TYPE A, MAXIMUM 8" LIFTS, COMPACTION: 95% OF MAXIMUM DENSITY PER MODIFIED PROCTOR TEST (ITEM NO. 20900) (5) 4" P.C.C. SIDEWALK (ITEM NO. 705001)

6) BORROW, TYPE F, MAXIMUM 8" LIFTS, COMPACTION: 95% OF MAXIMUM DENSITY PER MODIFIED PROCTOR TEST 7) 6" MINIMUM OF TOPSOIL & PERMANENT GRASS SEED (DRY GROUND) WITH 6:1 SIDE SLOPES (ITEM NO.

(8) PROFILE GRADE APPLICATION

(9) P.C.C. CURB & GUTTER, TYPE 3-8 (ITEM NO. 701023)

LEGEND

BORROW, TYPE C, MAXIMUM 8" LIFTS, COMPACTION: 95% OF MAXIMUM DENSITY PER MODIFIED PROCTOR TEST (ITEM NO. 209004)

342 SSIONA FOOT FIXERS, L TOWN OF MILLVILLE, 1 DRED, SUSSEX COUNT 134-12. SHEET TITLE

REVISIONS

ADDENDUM

DATE

✓ DESCRIPTION

COMMENTS

REVISED PER TOWN ENGINEER

REVISED PER TOWN ENGINEER

PROJECT NOTES & TYPICAL SECTIONS

GENERAL NOTES

SPECIFICATIONS CIVIL ELEMENTS UNDER THIS CONTRACT SHALL BE CONSTRUCTED UTILIZING THE FOLLOWING INFORMATION IN THE HIERARCHY LISTED BELOW:

1. CONTRACT AGREEMENT BETWEEN OWNER AND CONTRACTOR.

2. APPROVED PLANS.

THE NEW BUILDING.

PROJECT NOTES

ROAD AND BRIDGE CONSTRUCTION MANUAL, 2016.

PLACEMENT OF FILL OR TOPSOIL.

AGGREGATE BASE COURSE, TYPE "B".

IS GIVEN TO THE CENTER OF THE STRUCTURE.

SHALL BE INSTALLED SURROUNDING THE DUMPSTER AREA.

4. STATE OF DELAWARE DEPARTMENT OF NATURAL RESOURCES AND ENVIRONMENTAL CONTROL EROSION AND SEDIMENT CONTROL HANDBOOK, APRIL 2014 OR MOST CURRENT AT DATE OF

ADVERTISEMENT. DELAWARE DEPARTMENT OF TRANSPORTATION STANDARD CONSTRUCTION DETAILS, 2017, OR MOST CURRENT AT ADVERTISEMENT.

DELAWARE DEPARTMENT OF TRANSPORTATION STANDARDS AND SPECIFICATIONS FOR BRIDGE AND ROAD CONSTRUCTION, 2016, OR MOST CURRENT AT DATE OF ADVERTISEMENT.

MAXIMUM ALGEBRAIC DIFFERENCE OF CROSS SLOPES SHALL NOT EXCEED 8%.

CONTRACTOR SHALL LOAD TEST ALL SUBGRADE SOIL PRIOR TO THE PLACEMENT OF THE SUBBASE COURSE. ALL UNSUITABLE MATERIAL FOUND SHALL BE EXCAVATED TO THE DEPTH OF STABLE SOIL AND BACKFILLED WITH APPROVED MATERIAL. THE CONTRACTOR SHALL COMPACT ALL MATERIALS TO MEET THE DELDOT STANDARD SPECIFICATIONS.

3. SEE GRADES AND GEOMETRICS FOR FURTHER DETAILS.


4. DELAWARE 57 STONE OR BORROW, TYPE B, SHALL BE UTILIZED FOR ALL UNDERCUT LOCATIONS AS DIRECTED BY ENGINEER IN THE FIELD.


TOWN OF MILLVILLE **SUBMISSION** AUGUST 2023


CHK'D/DESIGNER AES/DLD SCALE SHEET NO.

20233371.002A

AS NOTED

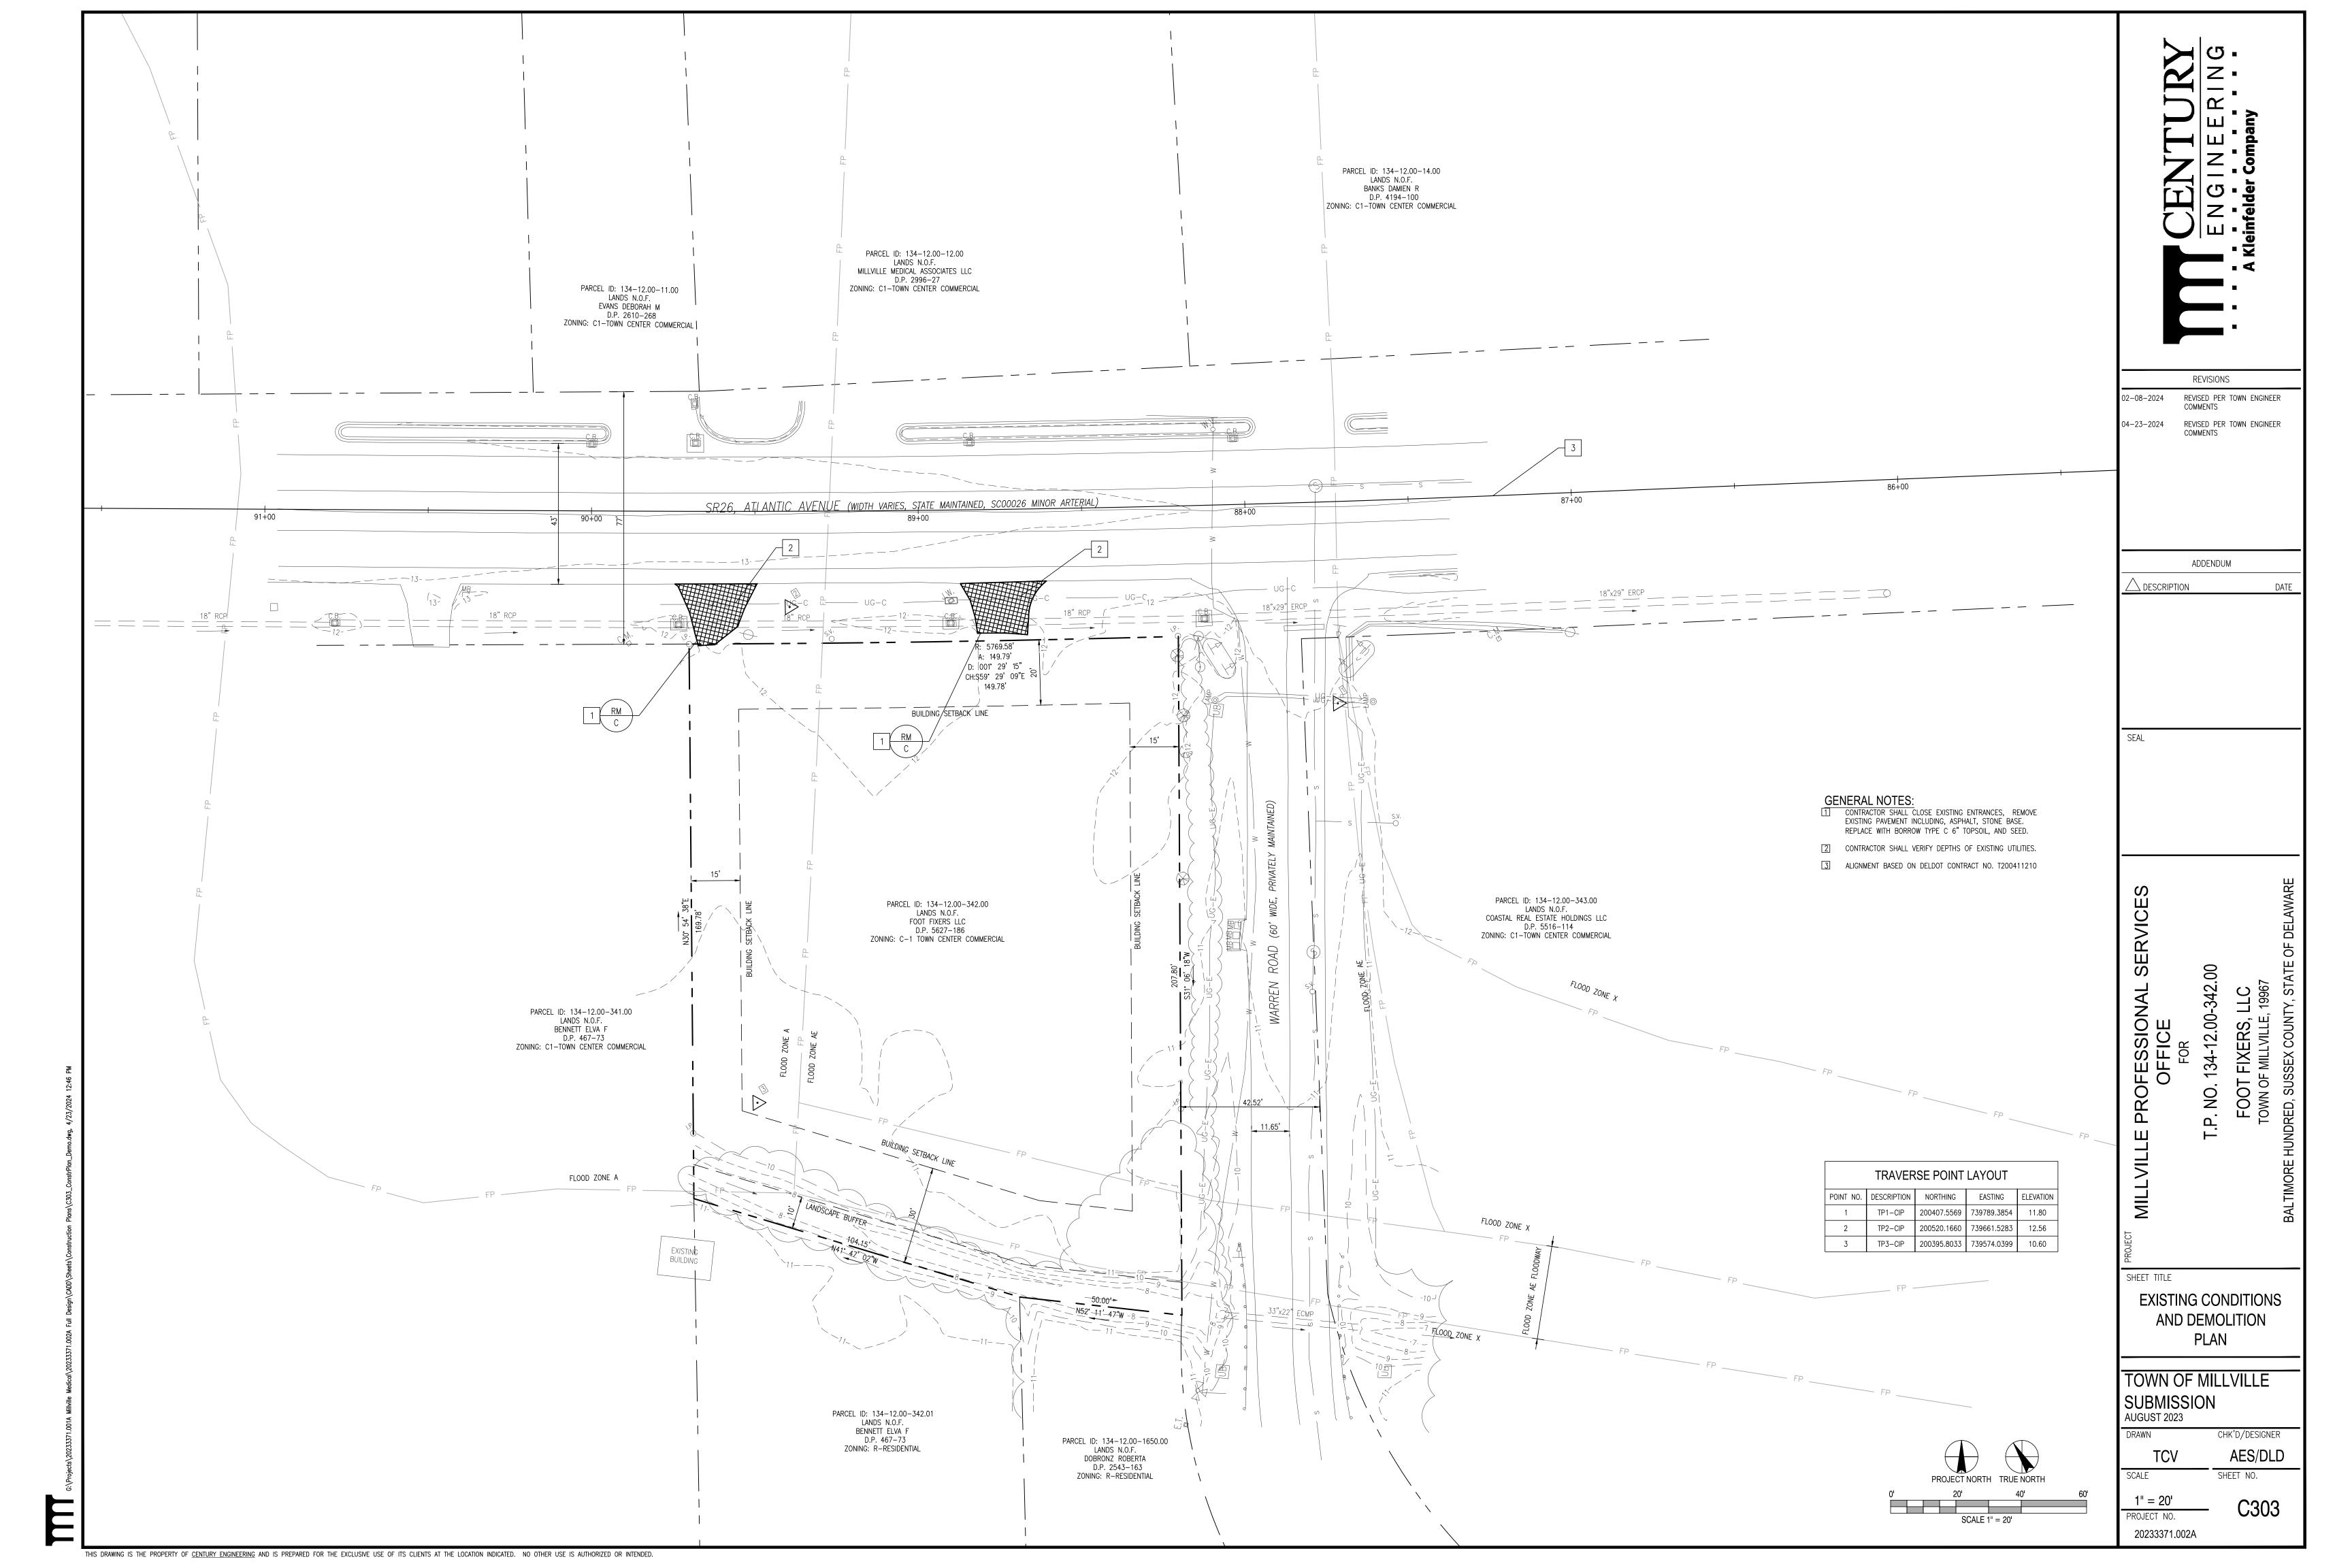

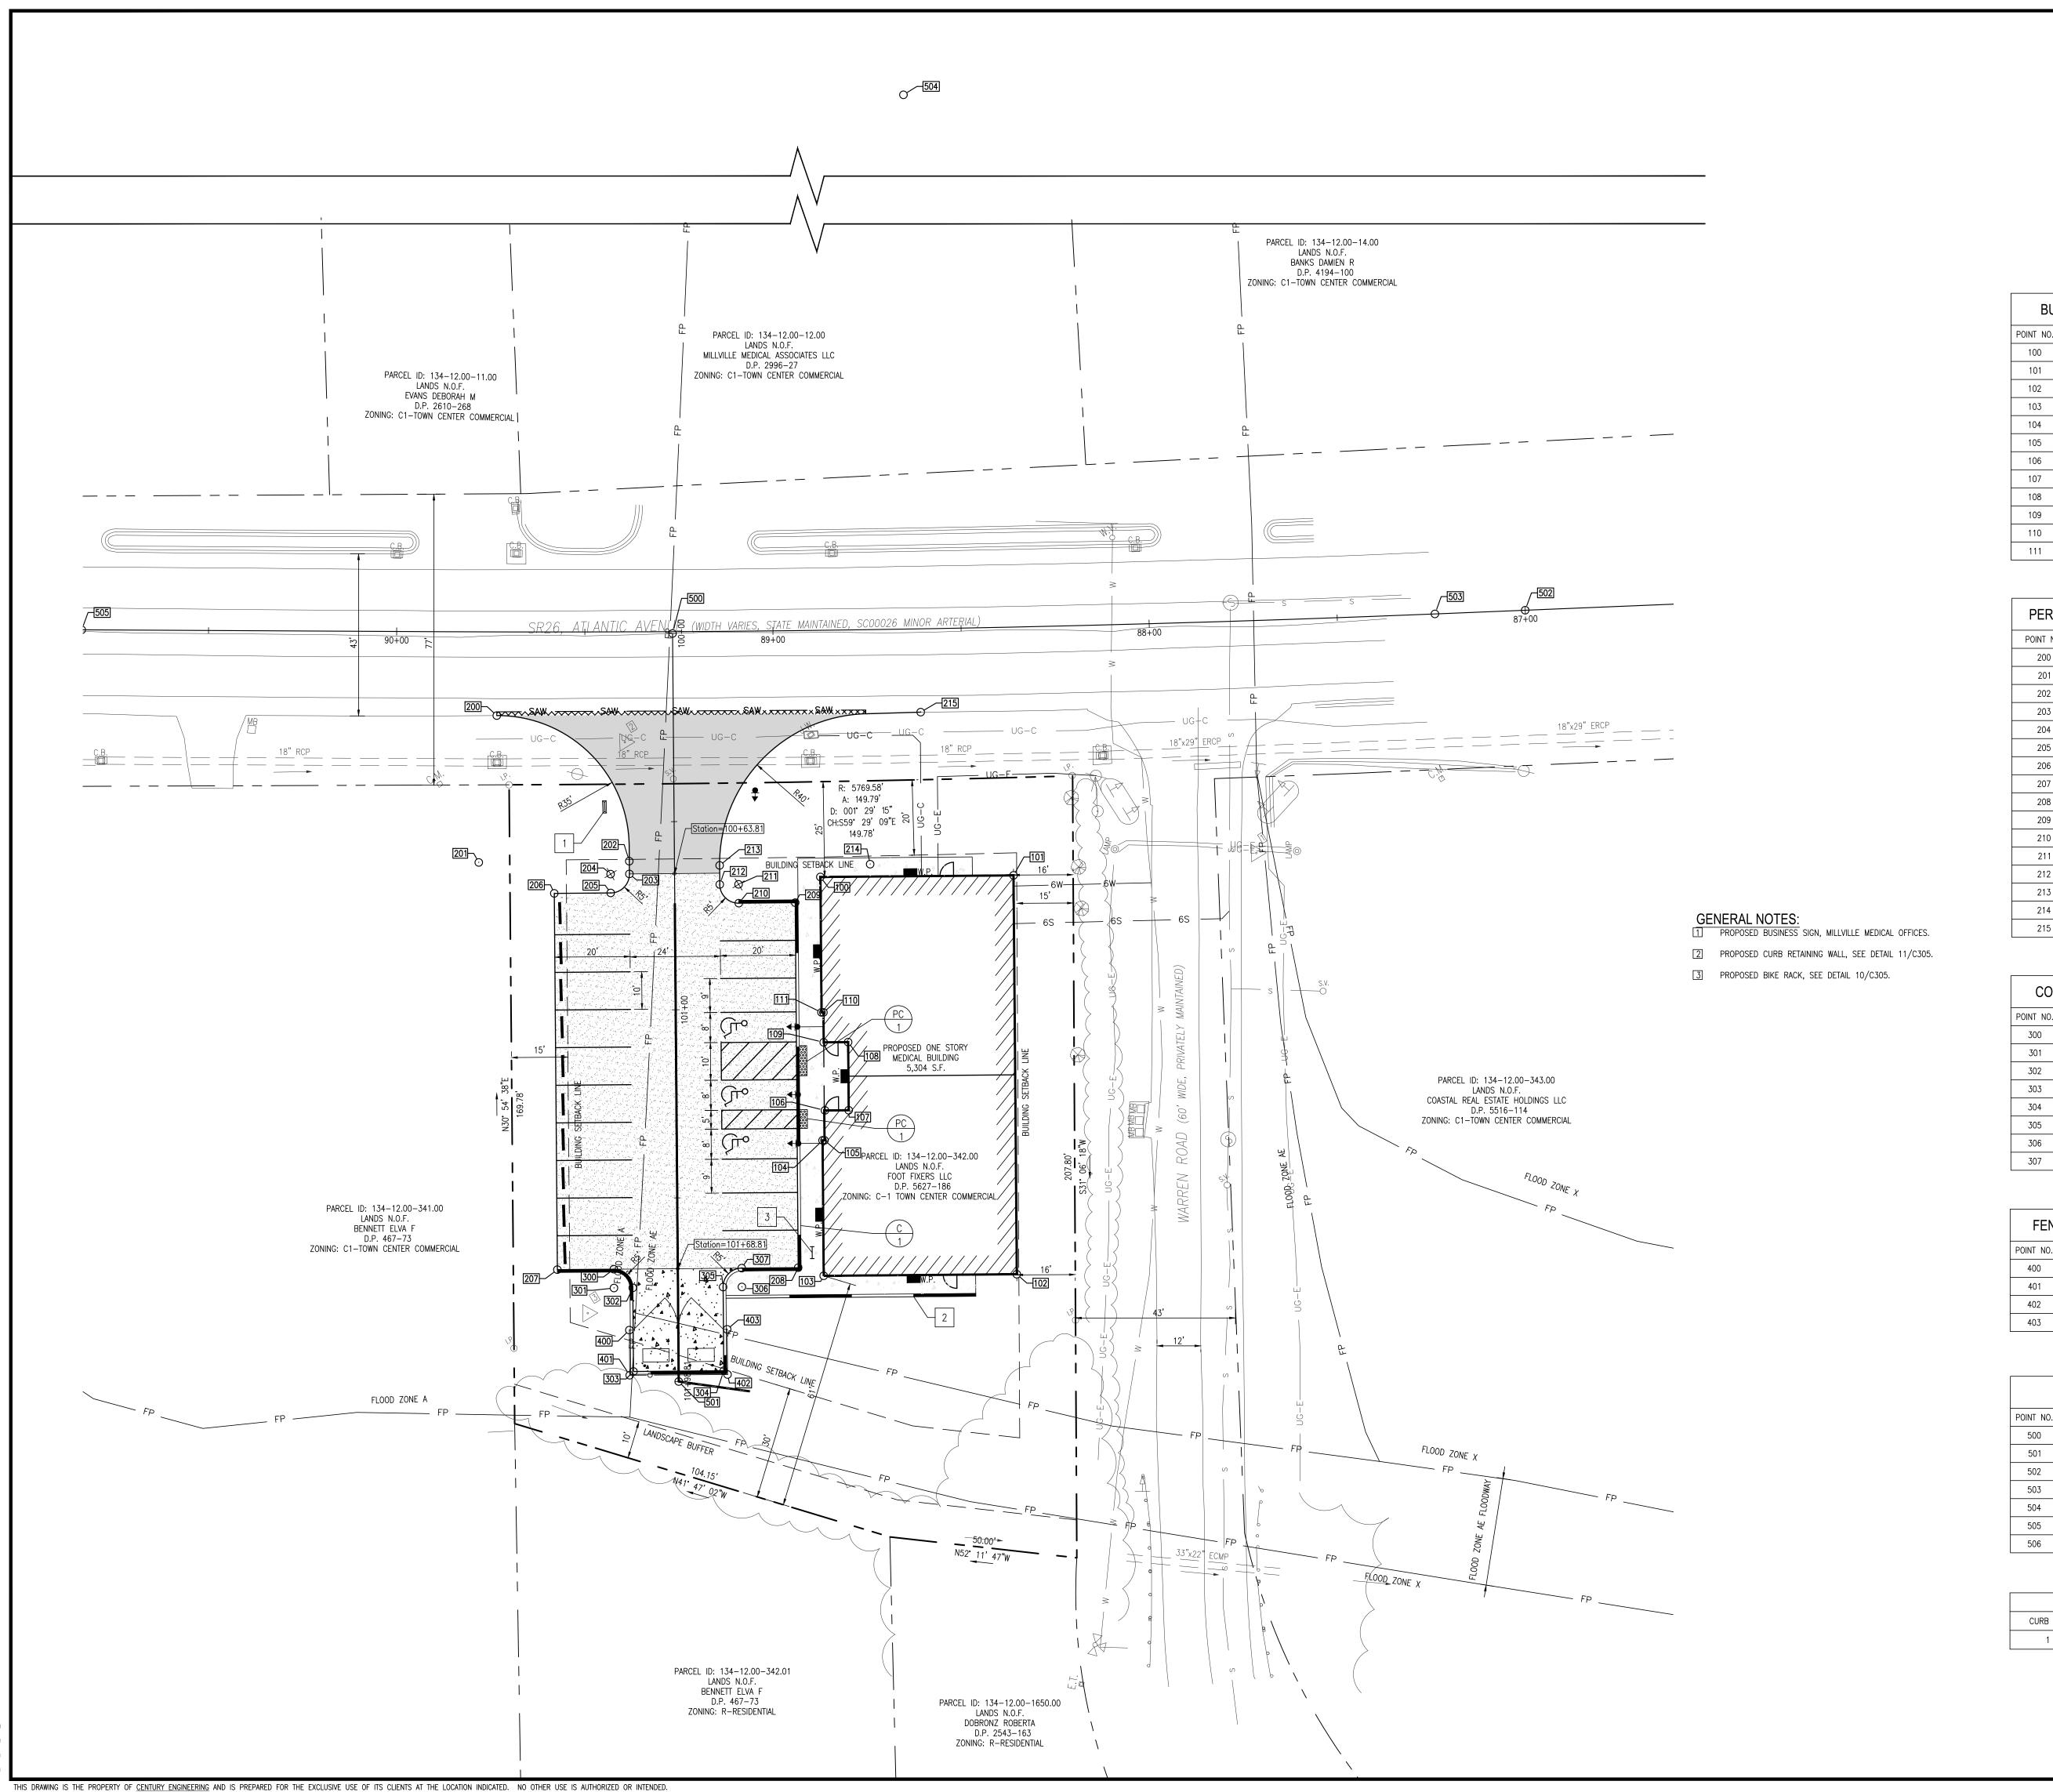

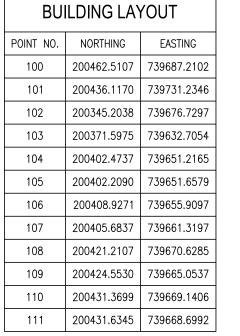


PERMEABLE PAVEMENT LAYOUT			
POINT NO.	NORTHING	EASTING	
200	200543.9327	739636.1702	
201	200513.1230	739611.7440	
202	200492.5551	739646.0508	
203	200489.6521	739644.3104	
204	200492.2231	739640.0221	
205	200487.9347	739637.4511	
206	200495.6477	739624.5860	
207	200409.8805	739573.1663	
208	200376.9719	739628.0574	
209	200460.1661	739677.9344	
210	200467.8790	739665.0693	
211	200472.1674	739667.6403	
212	200474.7384	739663.3520	
213	200479.0840	739665.9573	
214	200458.5162	739700.2642	
215	200485.9998	739732.7922	

CONCRETE LAYOUT				
POINT NO.	NORTHING	EASTING		
300	200402.1674	739586.031		
301	200397.8790	739583.460		
302	200395.3080	739587.749		
303	200376.2435	739576.3190		
304	200363.9027	739596.903		
305	200382.9674	739608.332		
306	200380.3965	739612.621		
307	200384.6848	739615.192		

FENCE LINE LAYOUT			
POINT NO.	NORTHING	EASTING	
400	200386.1922	739581.1178	
401	200375.9000	739574.9472	
402	200362.5309	739597.2467	
403	200372.8229	739603.4170	

ALIGNMENT LAYOUT					
POINT NO.	STATION	OFFSET	NORTHING	EASTING	RADIUS
500	100+00.00	0.00	200538.2084	739687.4125	
501	101+98.81	0.00	200367.6960	739585.1859	
502	87+00.00	0.00	200425.3866	739884.0097	
503	87+24.00	0.00	200437.0466	739863.0331	
504			205444.9526	742646.7253	5729.58
505	90+83.69	0.00	200620.8785	739553.9181	
506	91+00.00	0.00	200629.4523	739540.0423	

	CURB SCHEDULE			
CURB NO.	ITEM DESCRIPTION/TYPE	LENGTH		
1	P.C.C. CURB TYPE 1-8	296'		

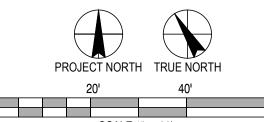

	REVISIONS	
08-2024	REVISED PER TOWN ENGINEER COMMENTS	-
23-2024	REVISED PER TOWN ENGINEER COMMENTS	

	VI LATOUT
ORTHING	EASTING
0543.9327	739636.1702
0513.1230	739611.7440
0492.5551	739646.0508
0489.6521	739644.3104
0492.2231	739640.0221
0487.9347	739637.4511
0495.6477	739624.5860
0409.8805	739573.1663
376.9719	739628.0574
0460.1661	739677.9344
)467.8790	739665.0693
)472.1674	739667.6403
)474.7384	739663.3520
0479.0840	739665.9573
0458.5162	739700.2642
1485 9998	739732 7922


FOOT FIXERS
T.P. NO. 134-12.0
FOR


T TITLE
SITE CONSTRUCTION
PLAN


TOWN OF MILLVILLE	
SUBMISSION AUGUST 2023	
AUGUST 2023	


AUGUST 2023		
DRAWN	CHK'D/DESIGNER	
TCV	AES/DLD	
SCALE	SHEET NO.	

1" = 20'
PROJECT NO.
20233371.002A

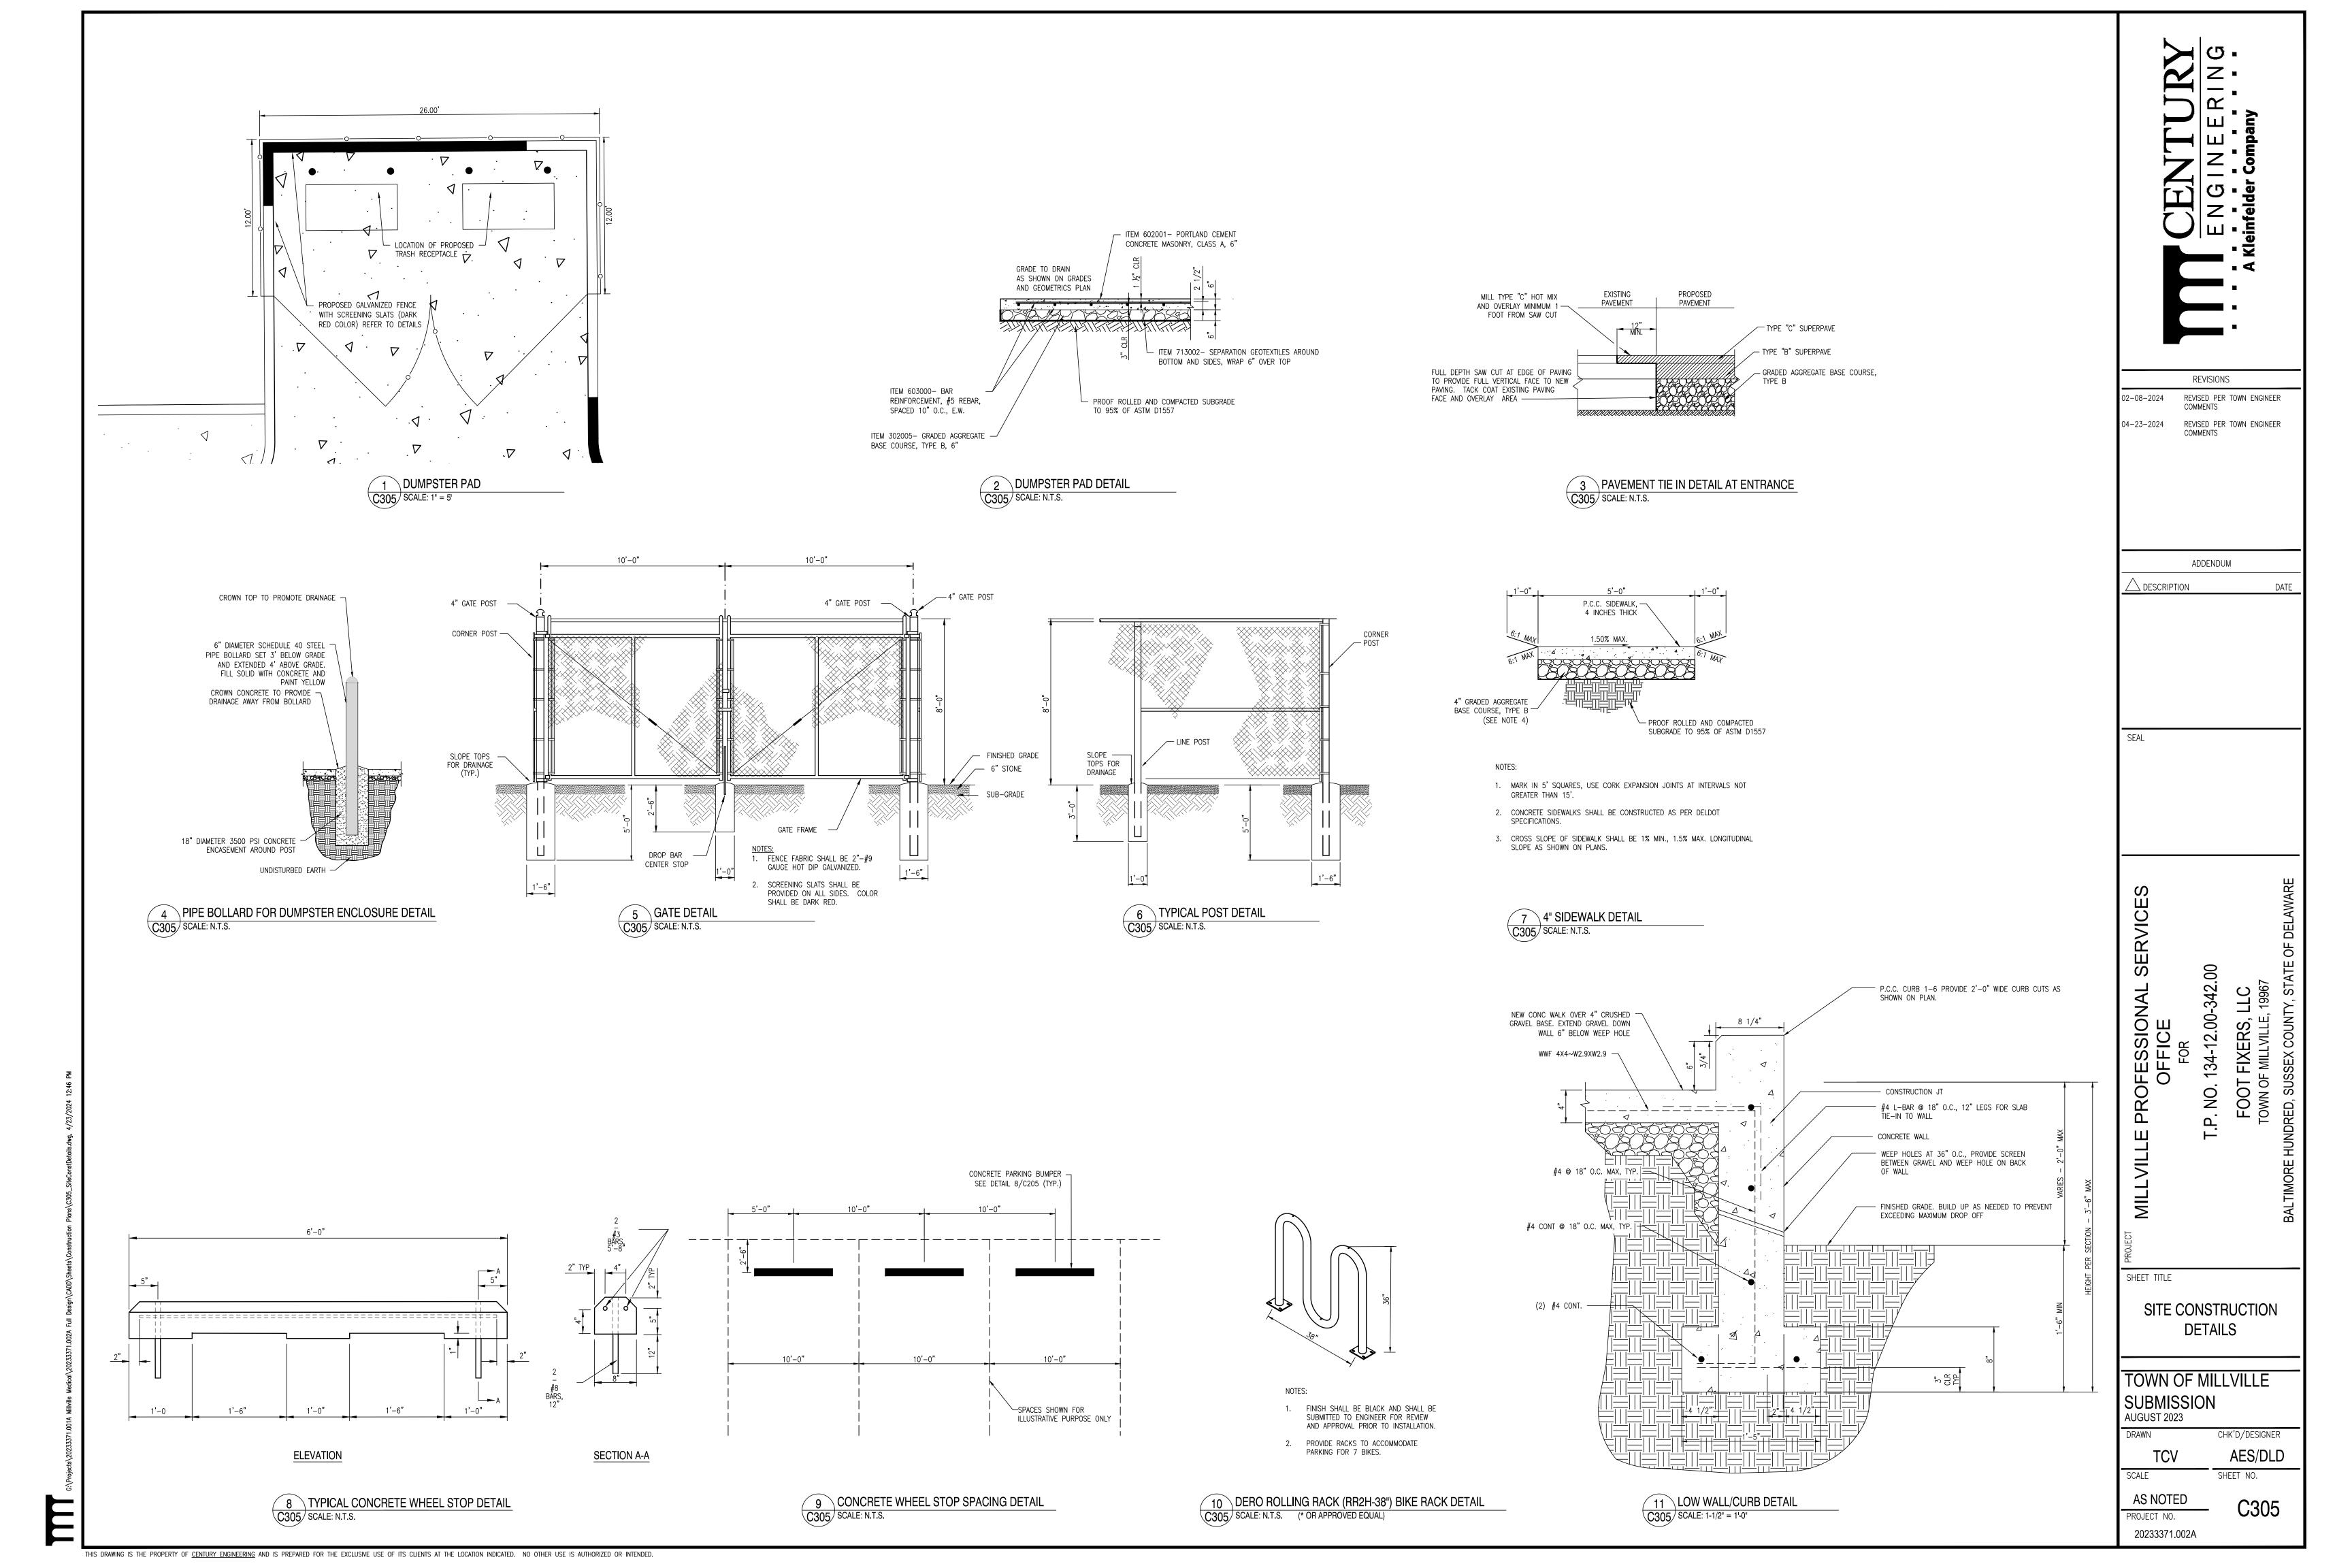


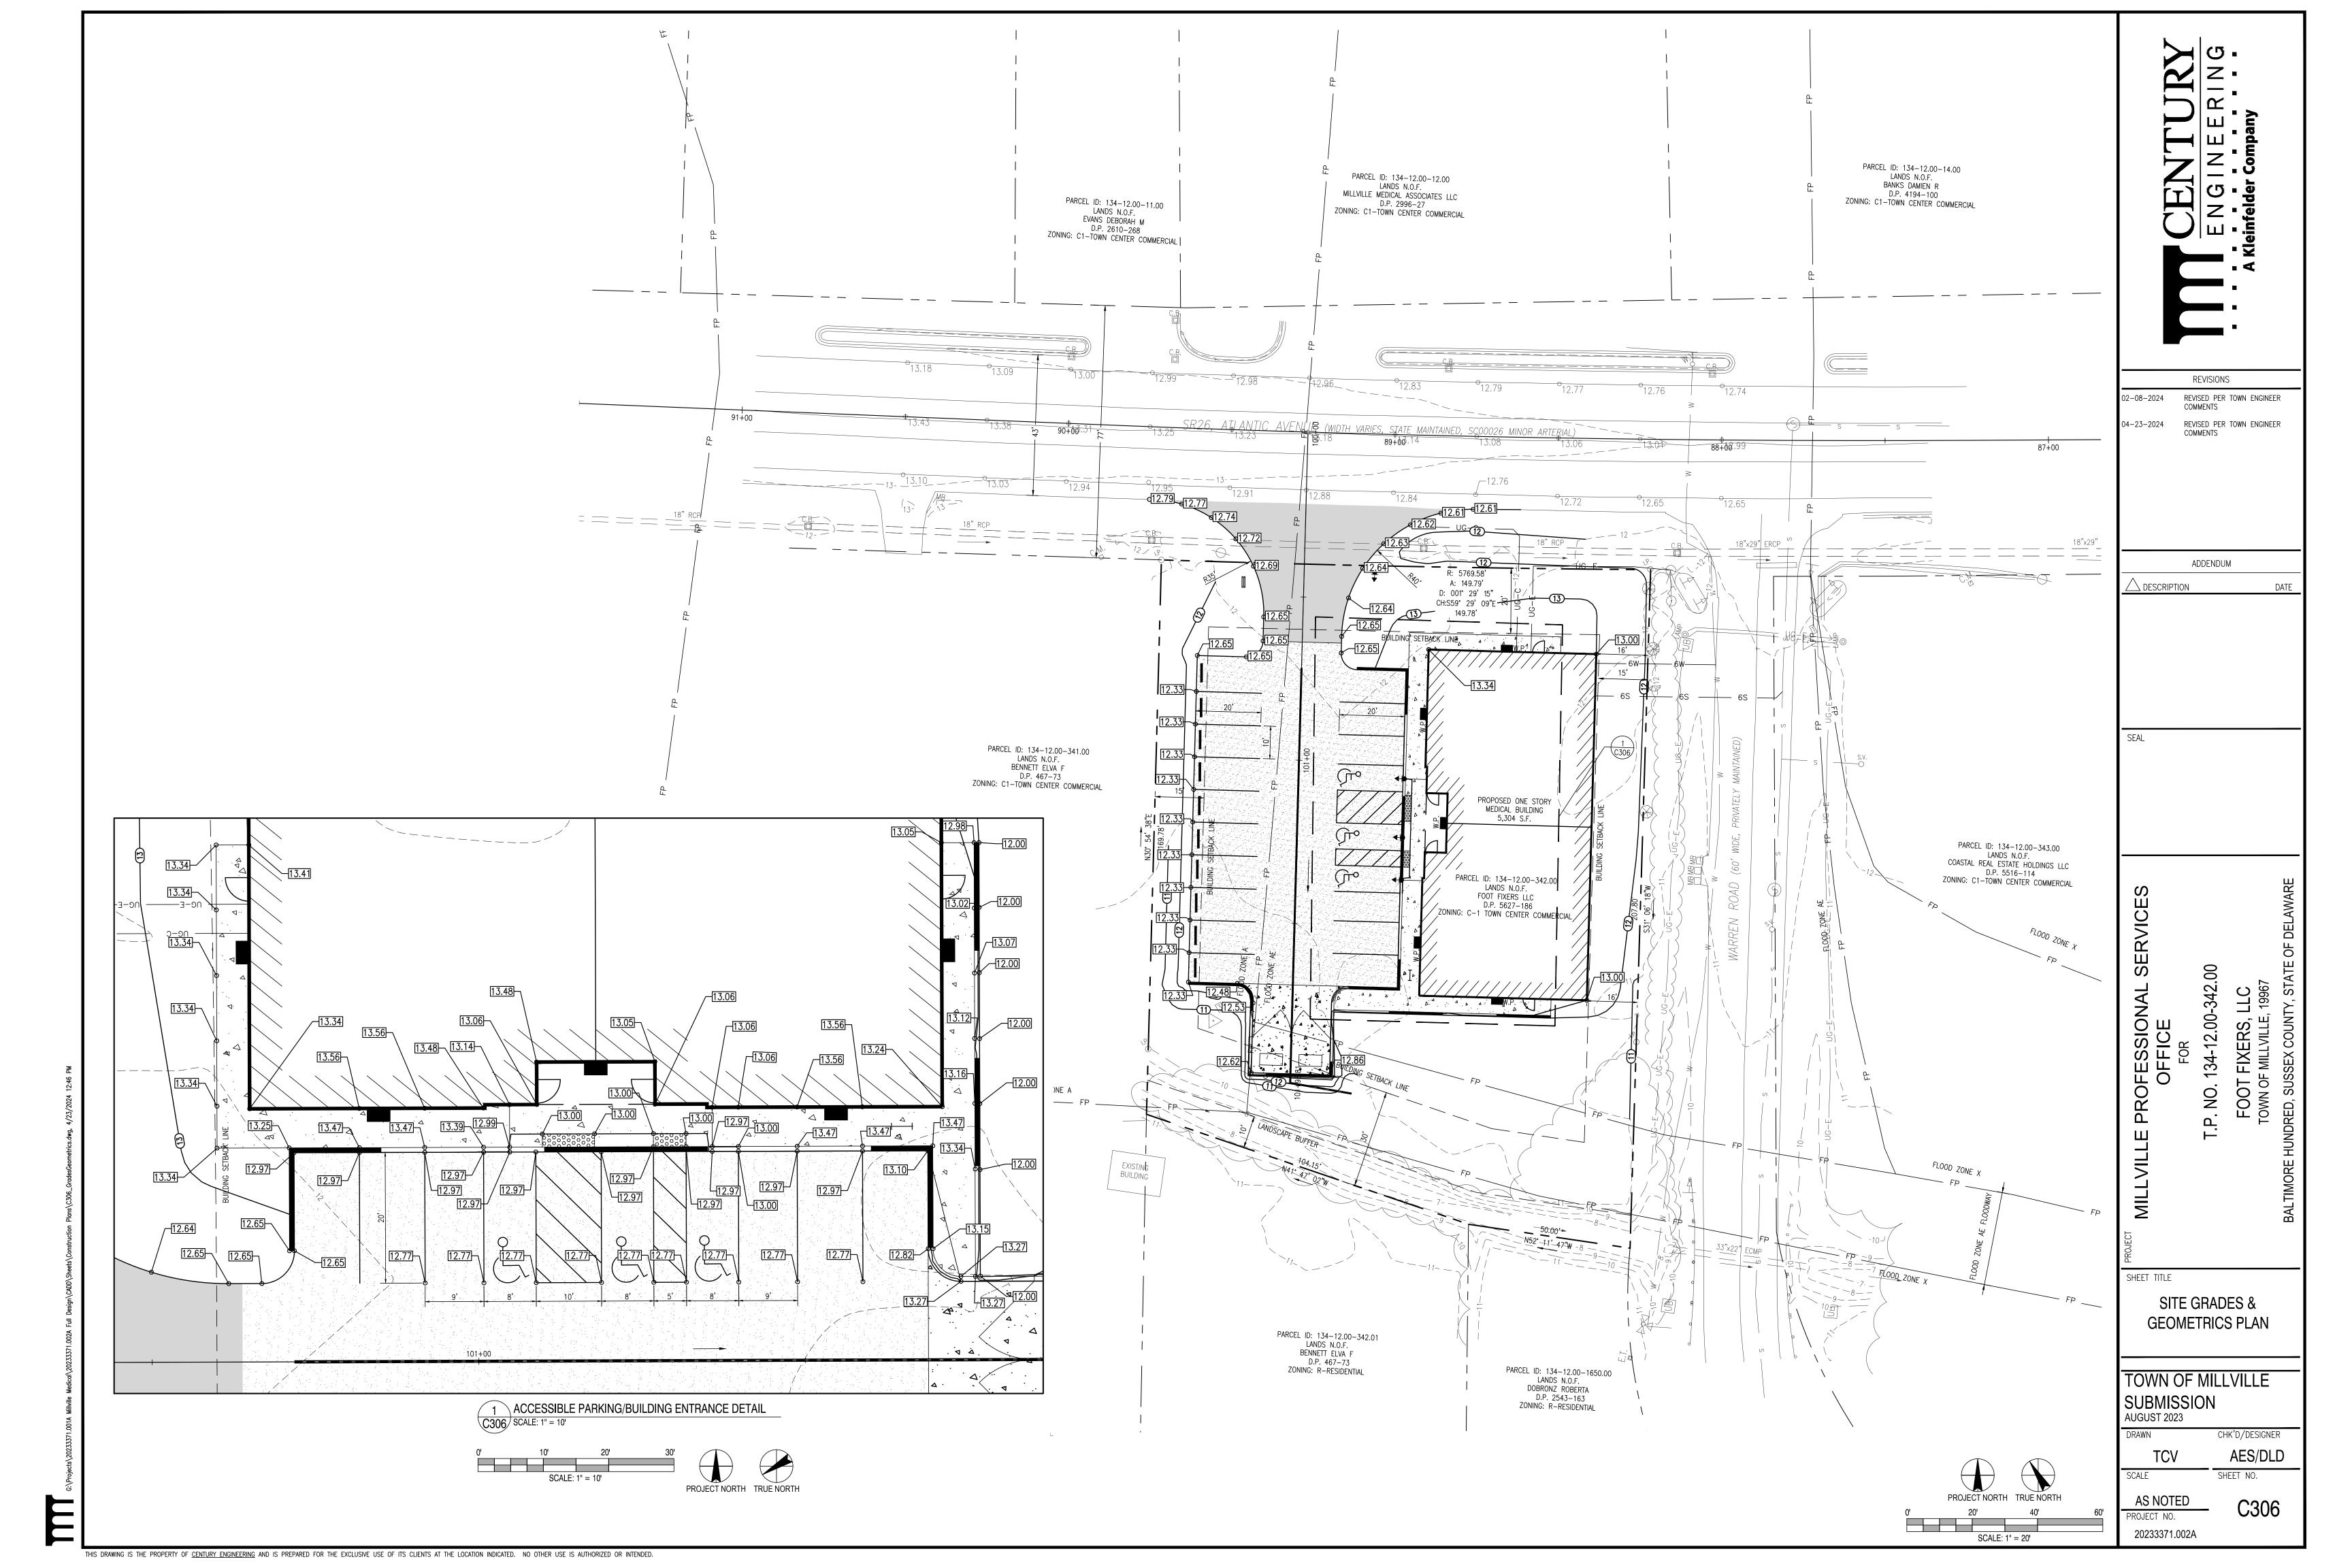

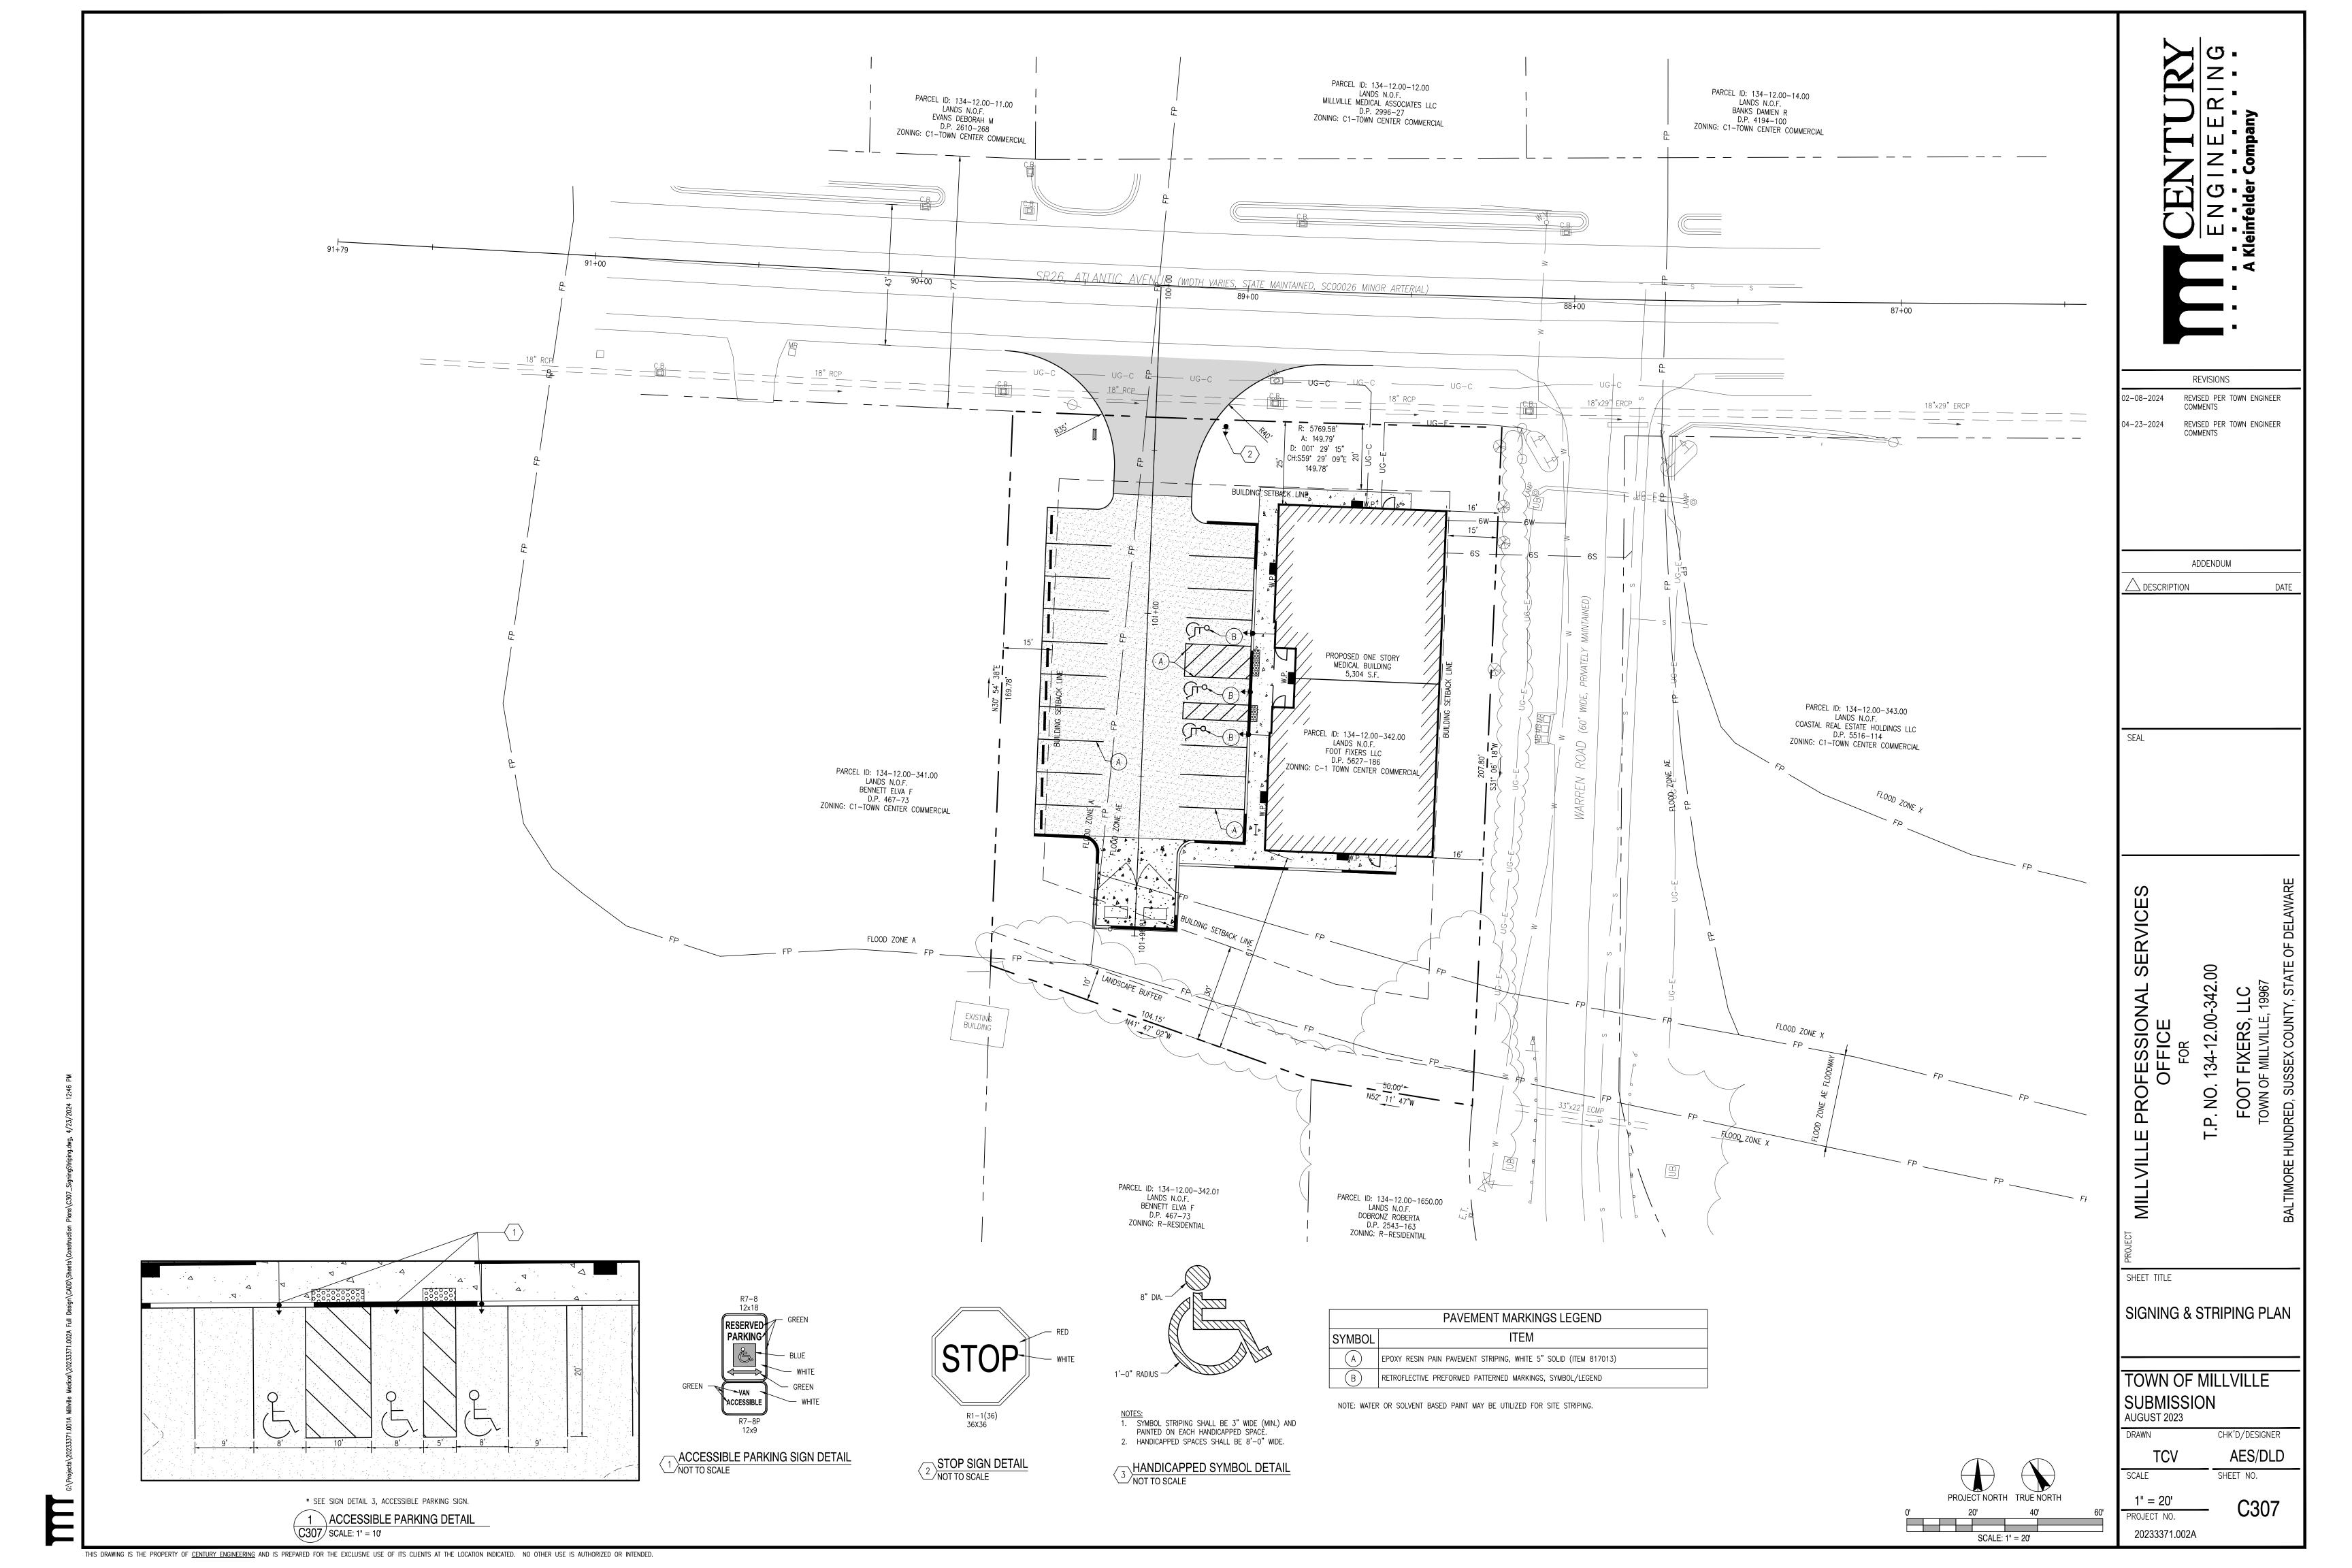

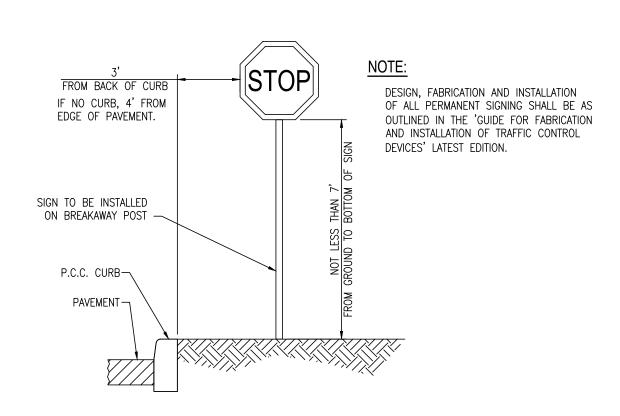




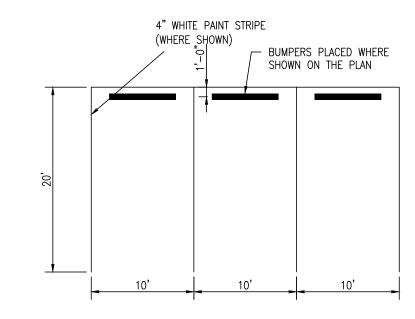


4 TYPICAL PARKING DETAIL C308 SCALE: NTS

NOTES:

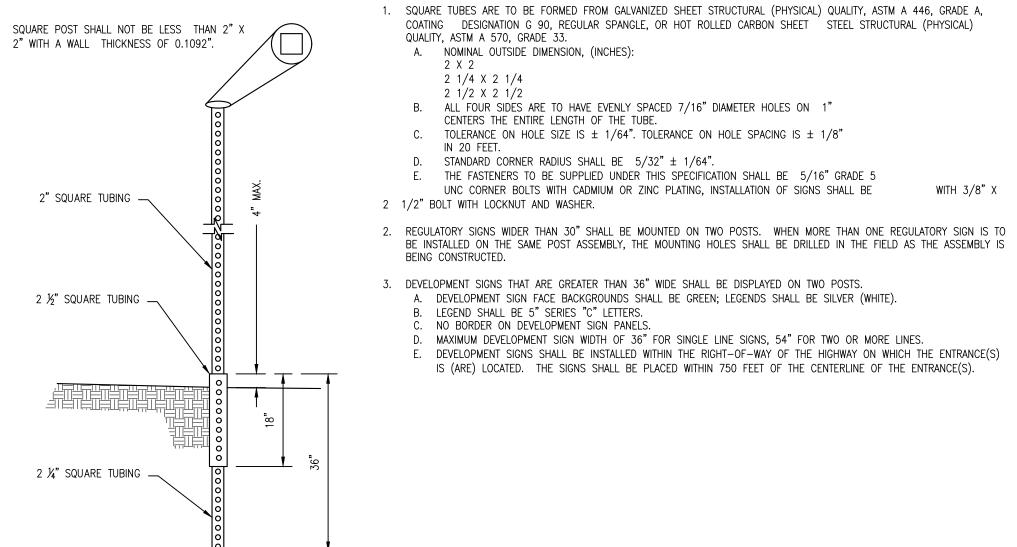

TELESCOPING STEEL SIGN POST BREAKAWAY ASSEMBLY C308 SCALE: NTS

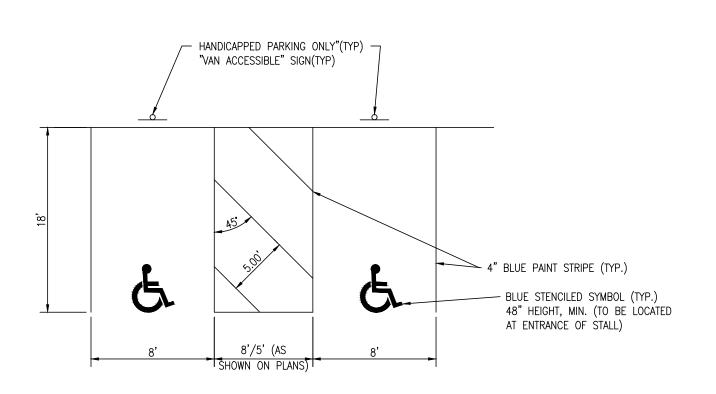

3 TYPICAL ACCESSIBLE PARKING DETAIL C308 SCALE: NTS

WITH 3/8" X



REVISIONS		
02-08-2024	REVISED PER TOWN ENGINEER COMMENTS	
04-23-2024	REVISED PER TOWN ENGINEER COMMENTS	

ADDENDUM	
<u> </u>	DATE

SEAL

PROFESSIONAL SOFFICE

SHEET TITLE

SIGNING & STRIPING **DETAILS**

TOWN OF MILLVILLE

SUBMISSION AUGUST 2023 CHK'D/DESIGNER AES/DLD


AS NOTED PROJECT NO. 20233371.002A

-0.28% 0.45% P-1_/ 127 L.F. PVC Pipe @ 0.0050 FT/FT 100+00 101+99 101+00


PARKING LOT PROFILE

SCALE: HORZ. 1" = 20'

VERT. 1" = 2'

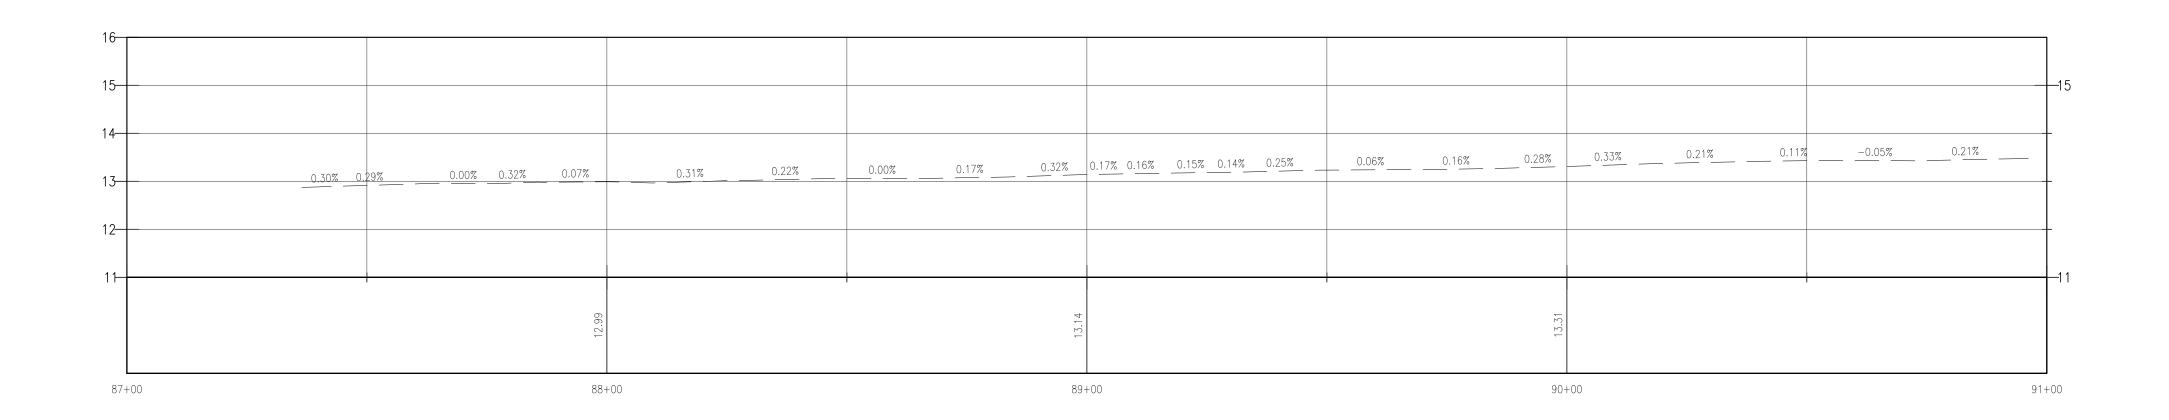

2 ATLANTIC AVENUE PROFILE
C309 SCALE: HORZ. 1" = 20'
VERT. 1"= 2'

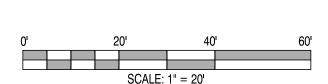

REVISIONS

02-08-2024 REVISED PER TOWN ENGINEER COMMENTS 04-23-2024 REVISED PER TOWN ENGINEER COMMENTS

ADDENDUM <u> DESCRIPTION</u> DATE

SEAL

MILLVILLE PROFESSIONAL SERVICES OFFICE


SHEET TITLE


ROAD PROFILES


TOWN OF MILLVILLE SUBMISSION AUGUST 2023 CHK'D/DESIGNER AES/DLD


SHEET NO. 1" = 20'
PROJECT NO. C309


20233371.002A

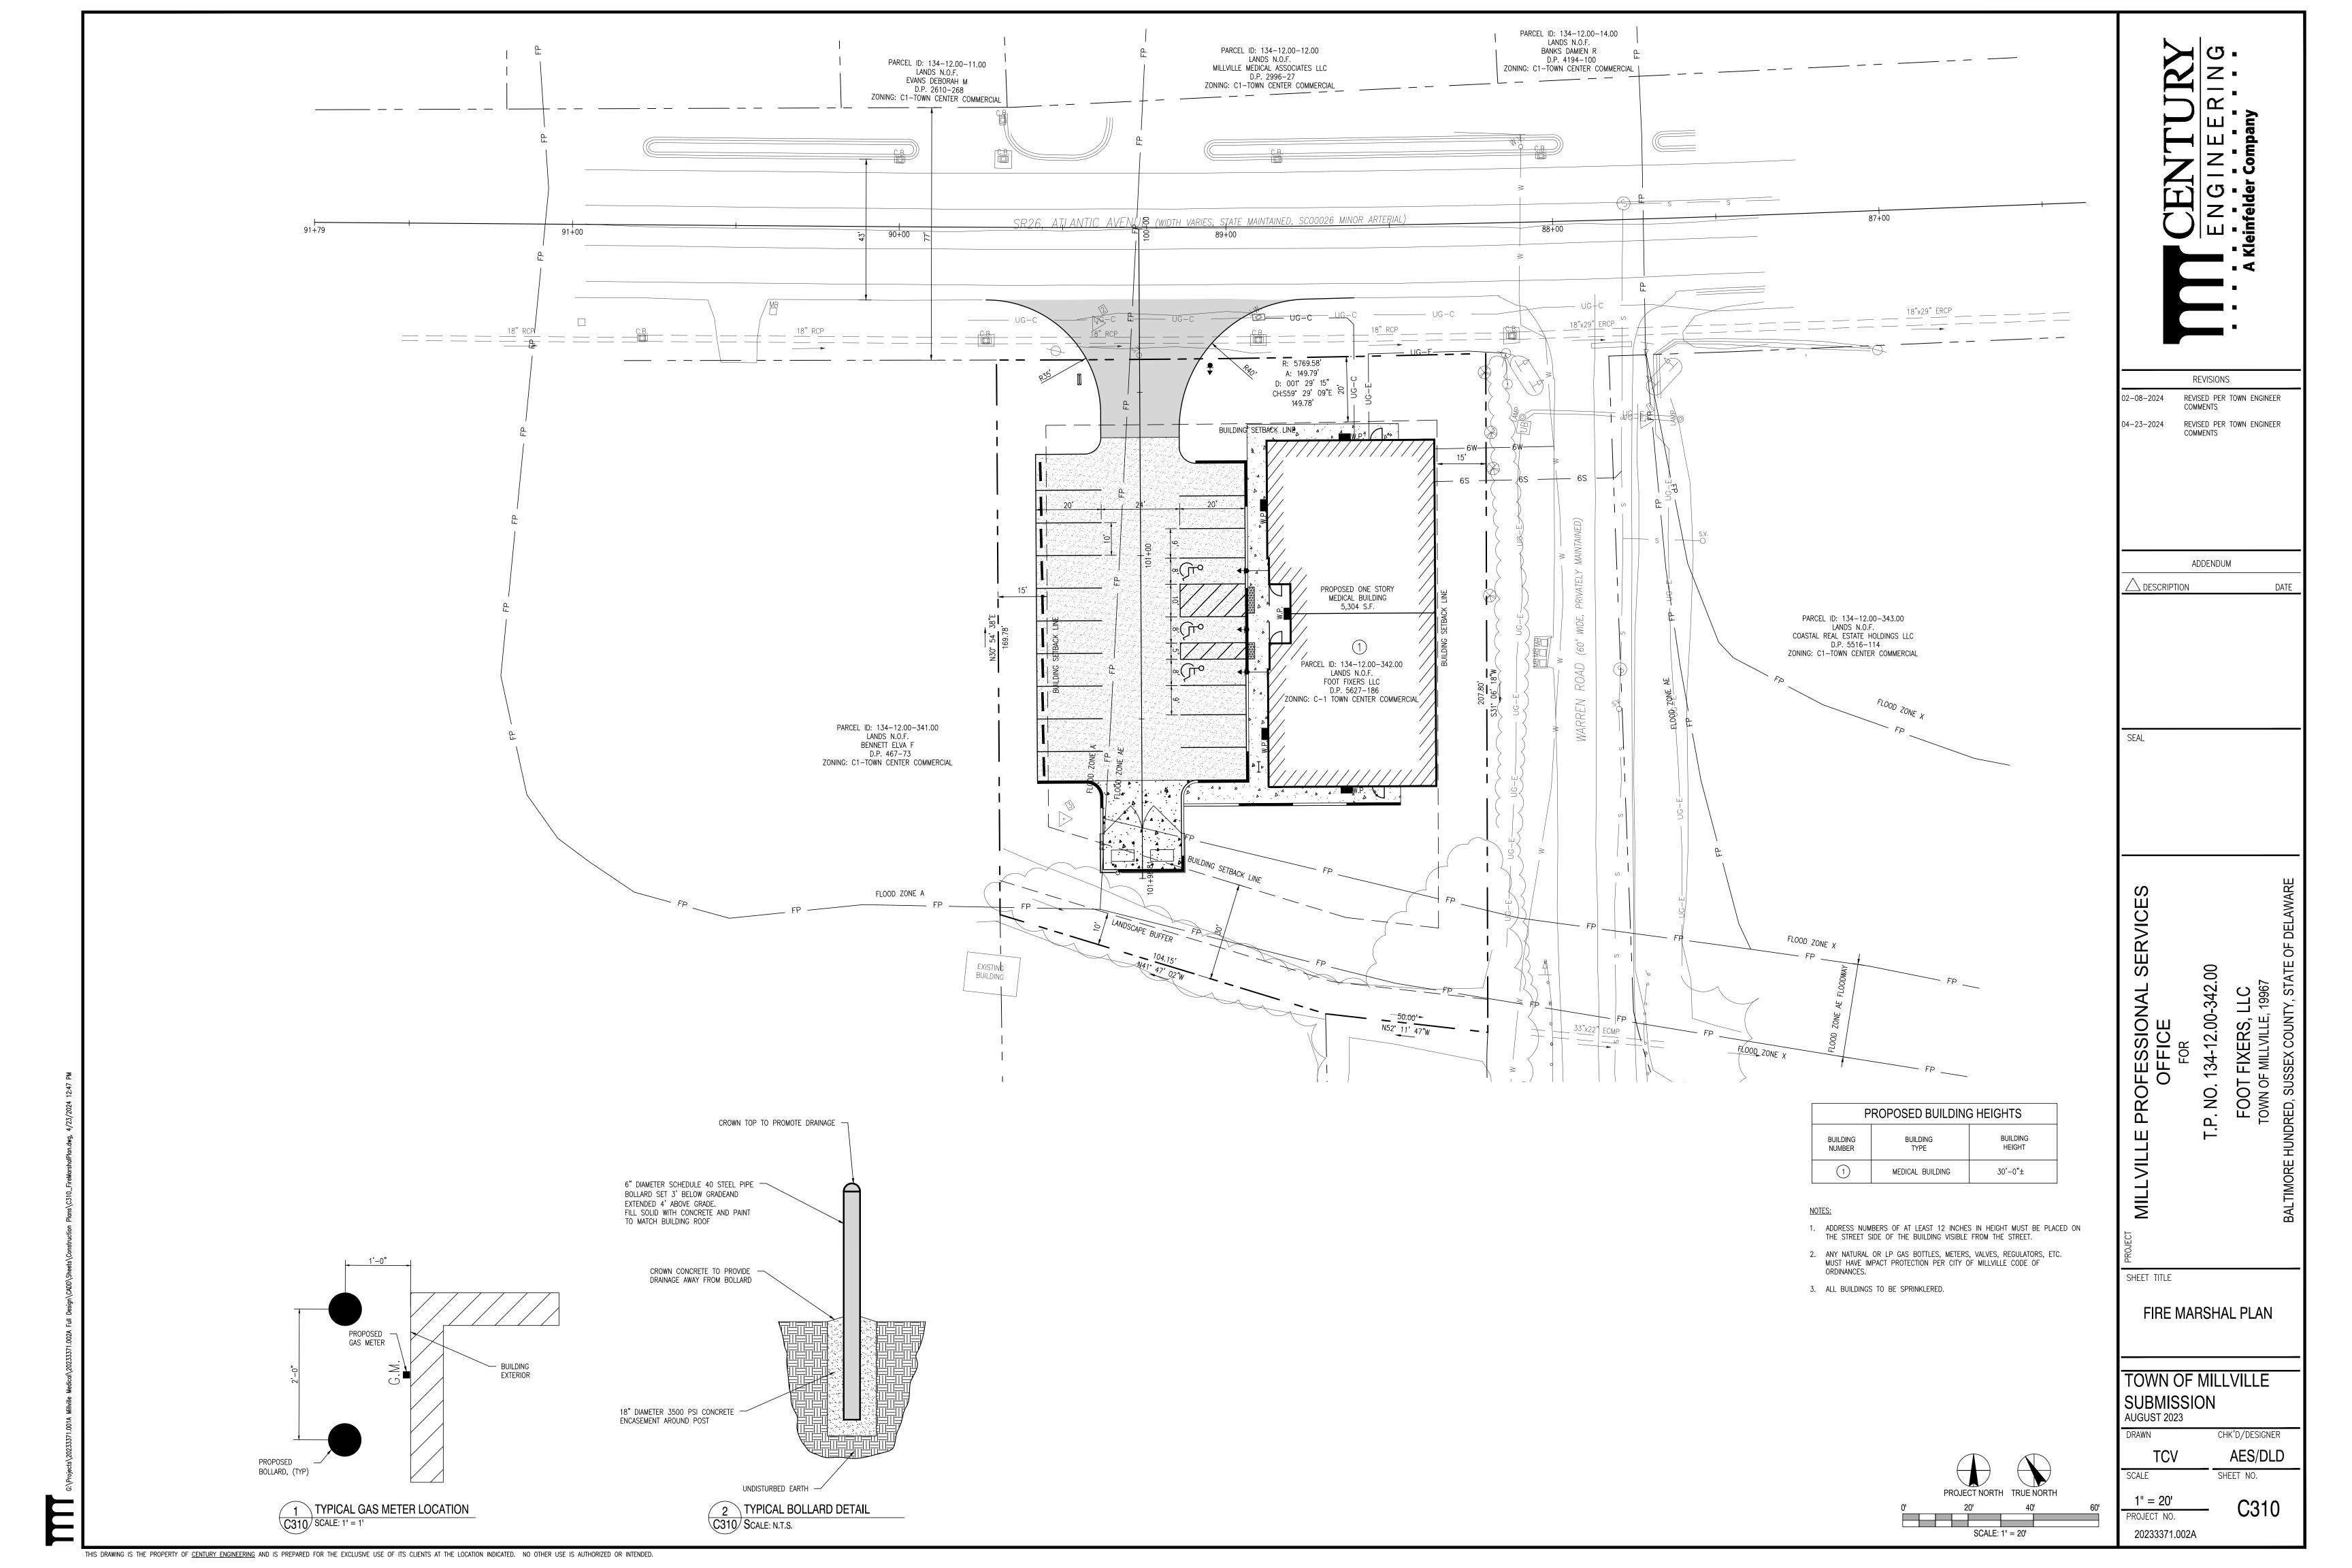

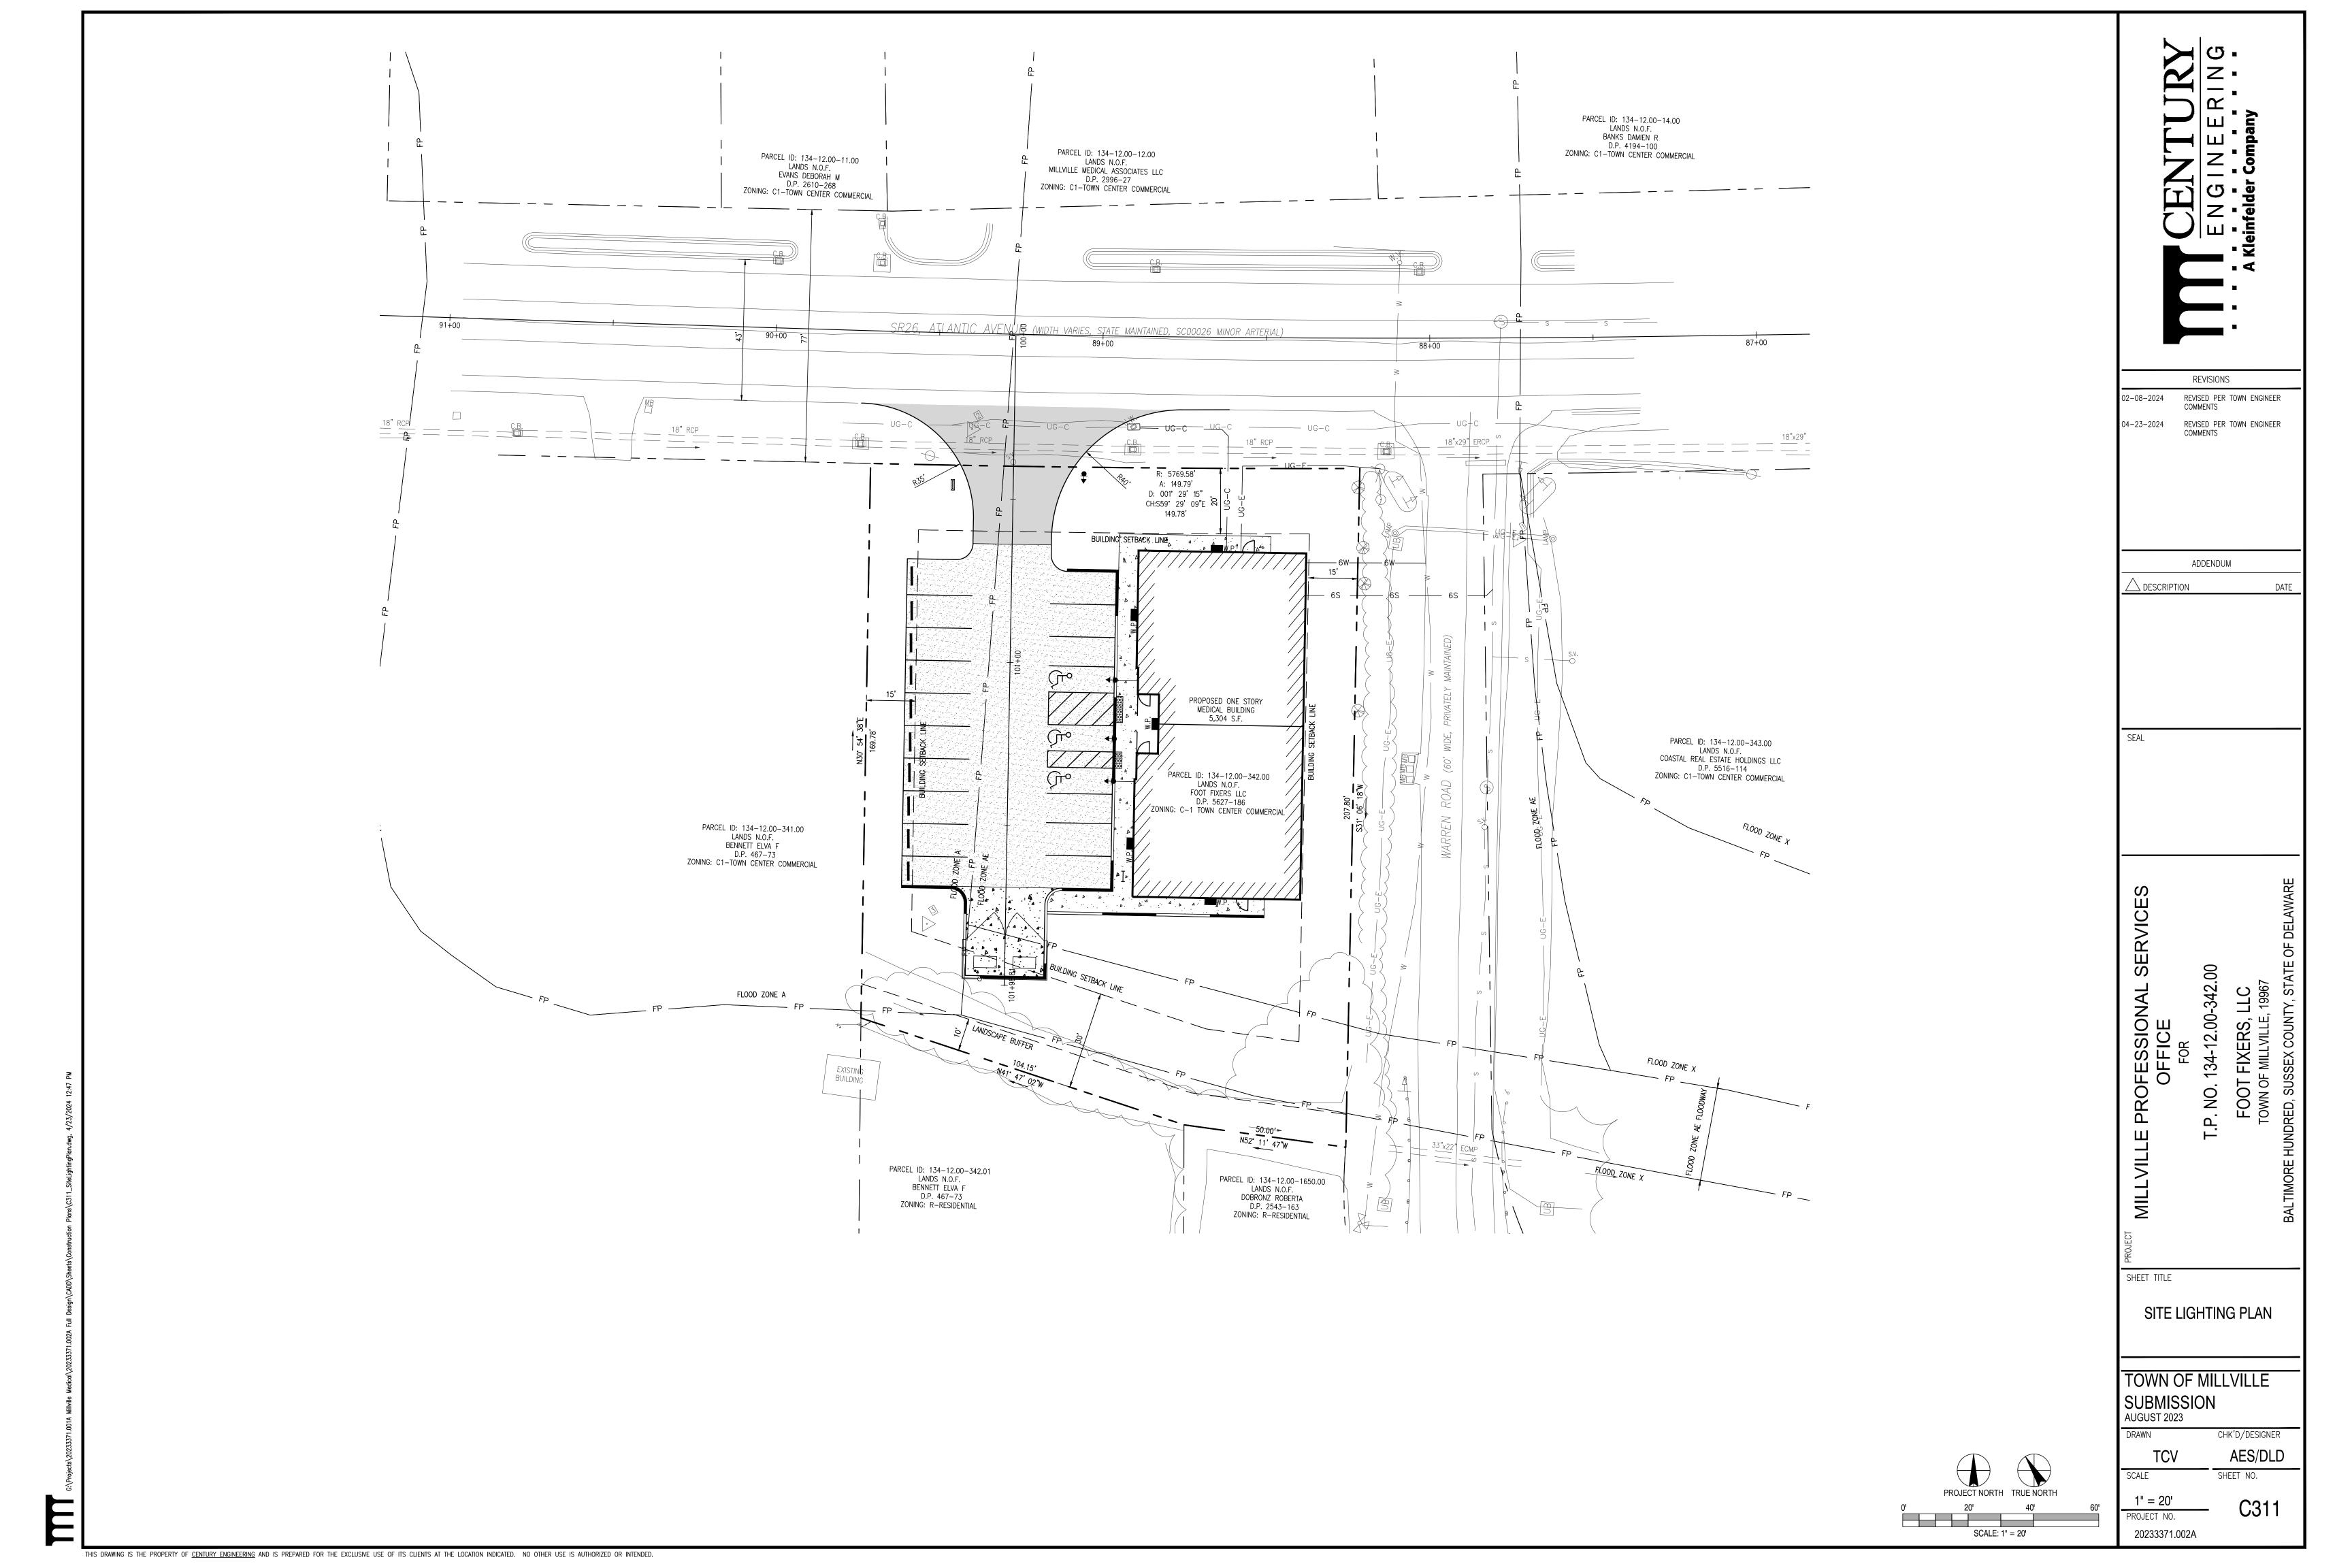


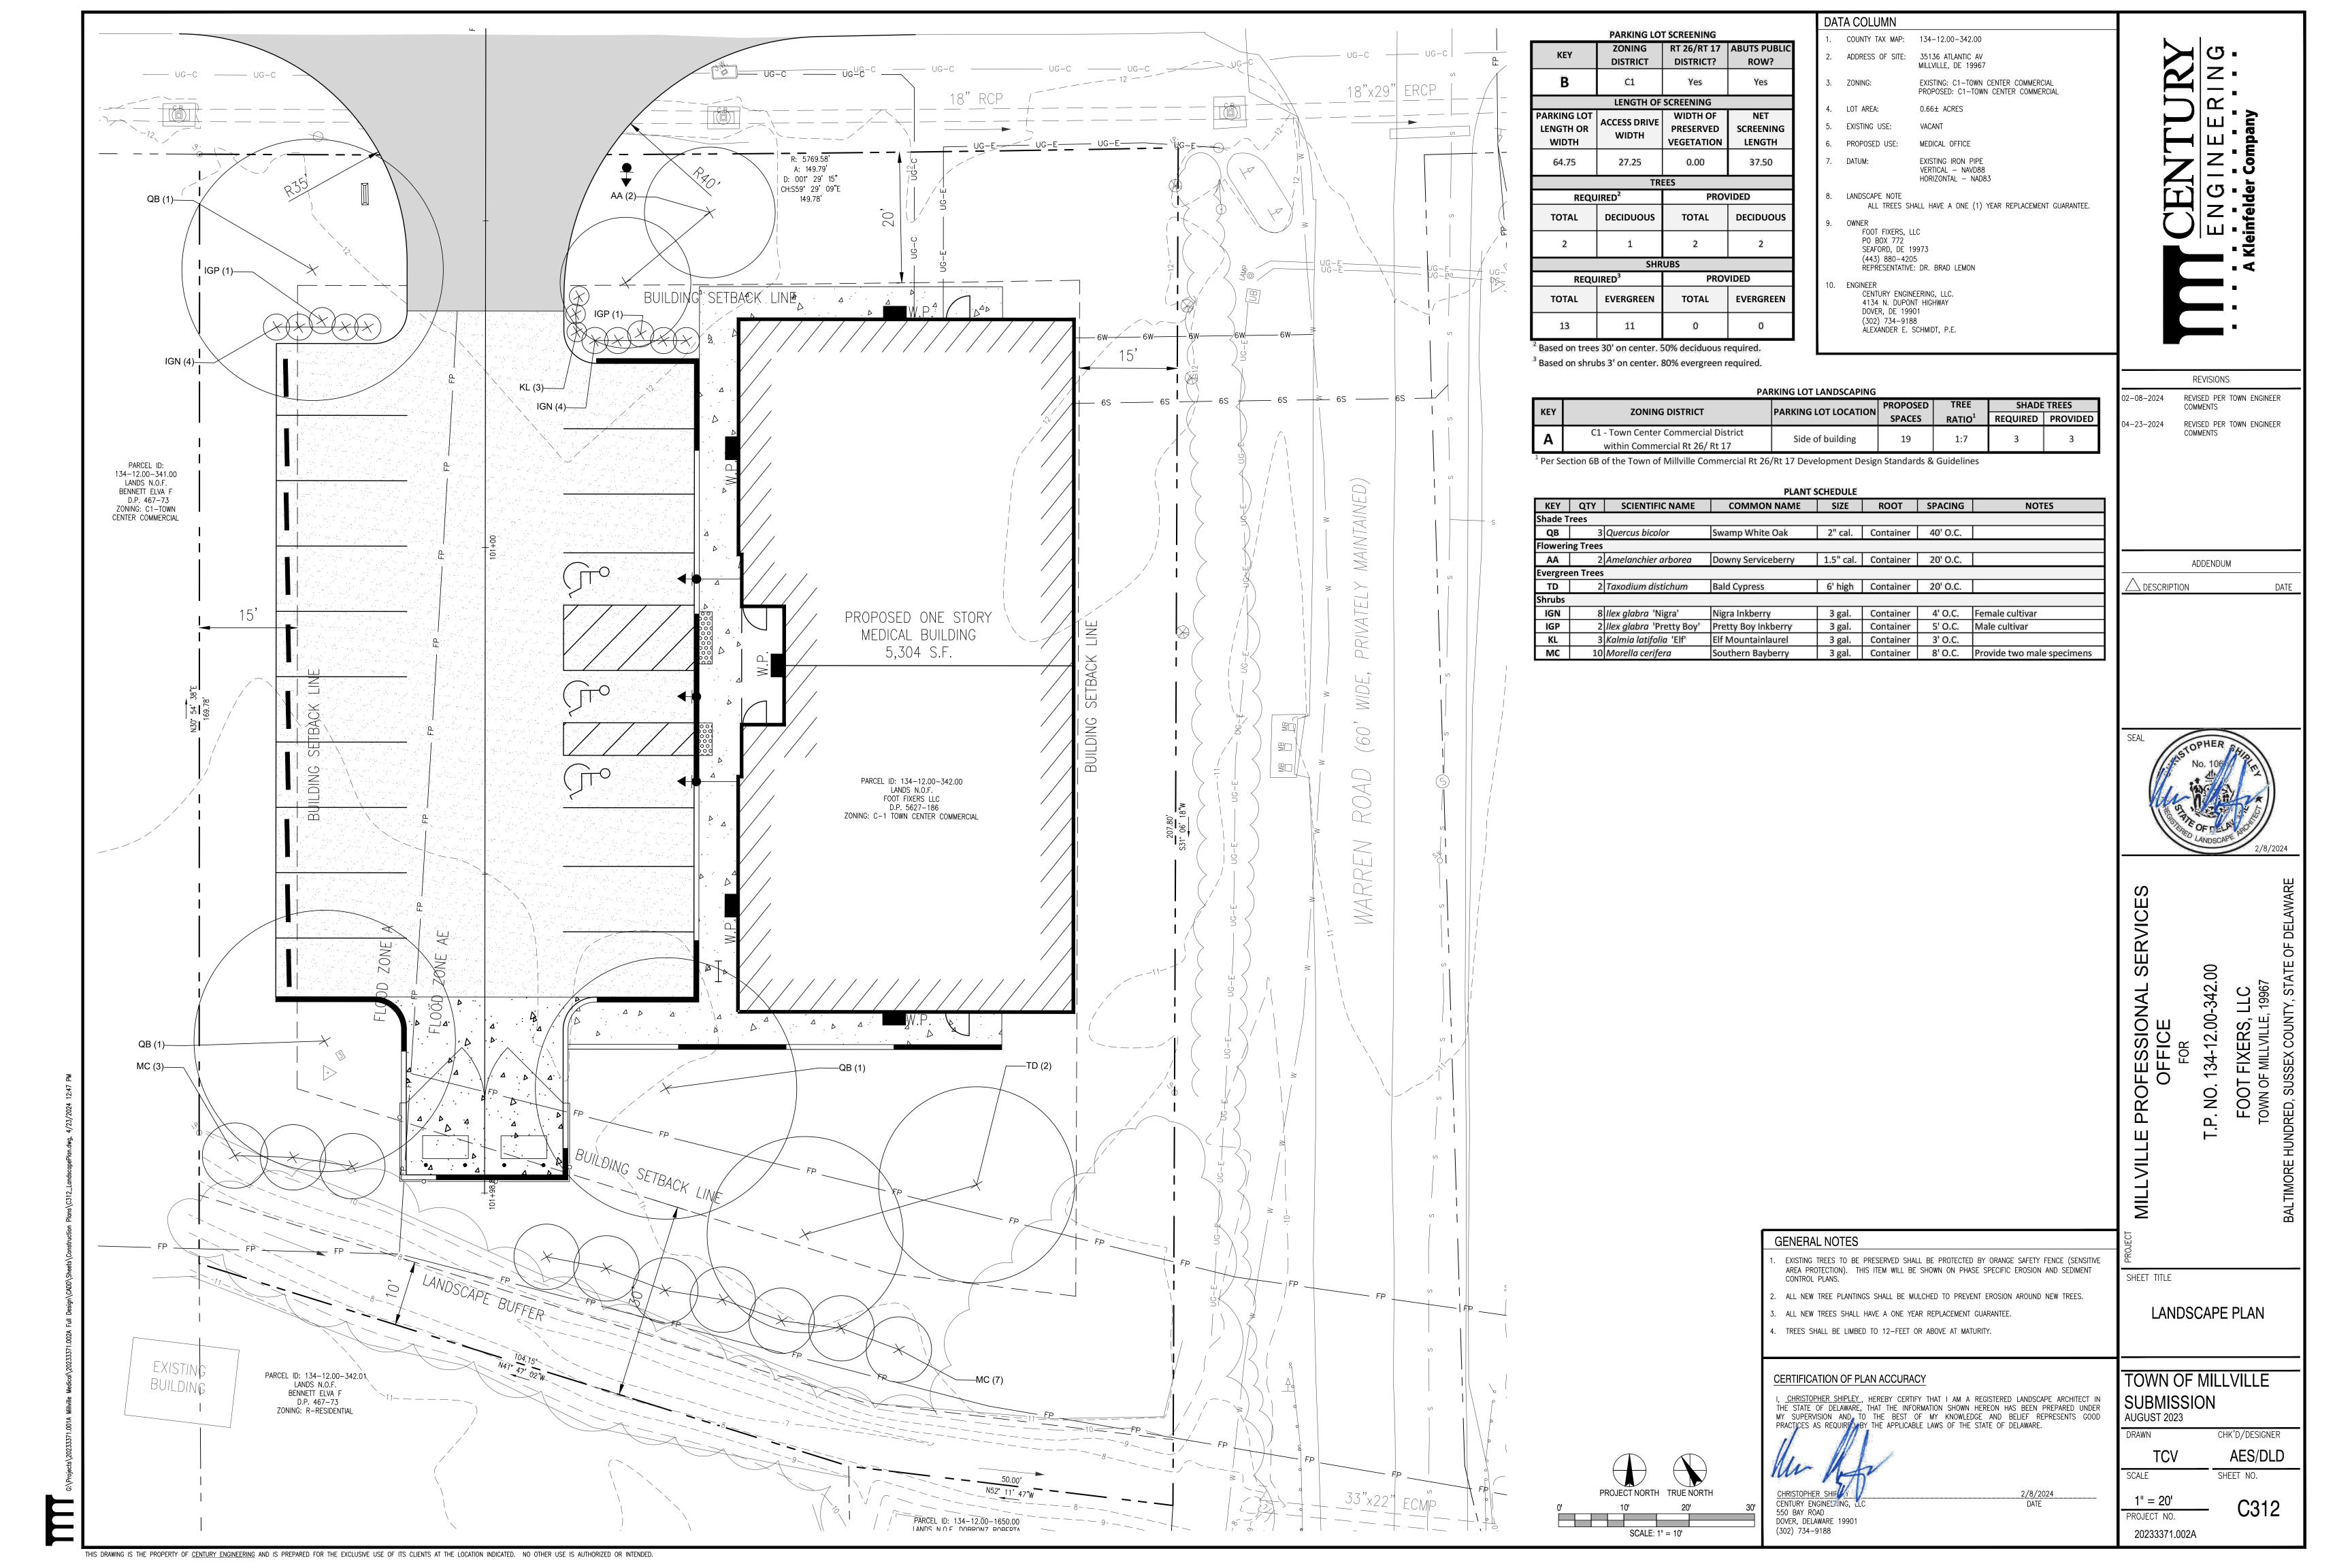

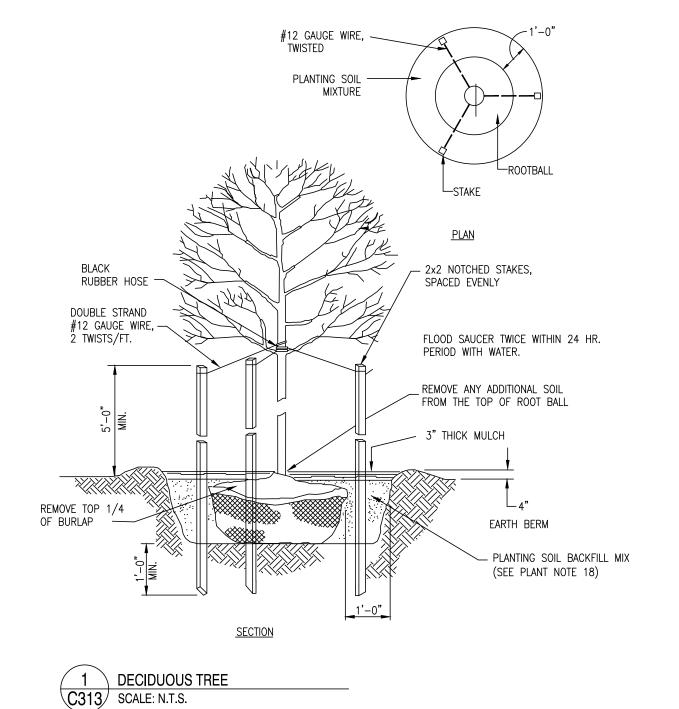

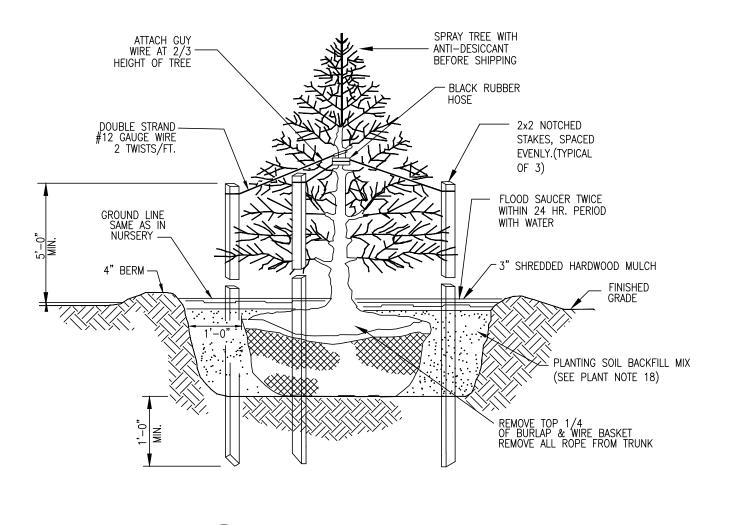

C313 SCALE: N.T.S.

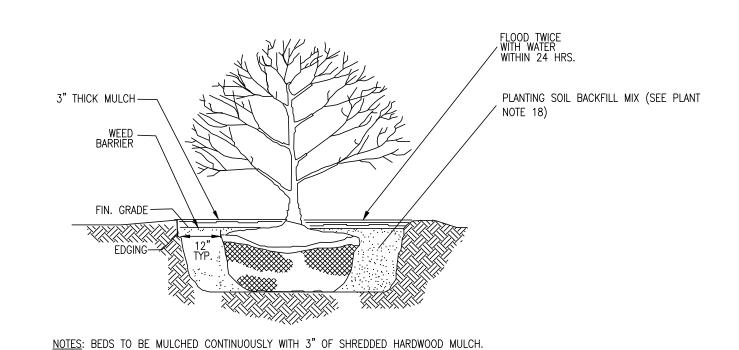

C313 SCALE: N.T.S.

PLANTING NOTES

- THE CONTRACTOR SHALL FURNISH AND PLANT ALL PLANTS SHOWN ON THE DRAWINGS AS SPECIFIED AND IN QUANTITIES INDICATED ON THE PLANT LIST.
 - ALL PLANTS SHALL BE FRESHLY DUG AND NURSERY GROWN. THEY SHALL HAVE BEEN GROWN UNDER CLIMATIC CONDITIONS SIMILAR TO THOSE AT THE SITE OR PROPERLY ACCLIMATED TO LOCAL CONDITIONS.
 - ALL PLANTS SHALL BE IN ACCORDANCE WITH ANSI Z60.1-2004
 - ALL PLANTS SHALL BE TYPICAL OF THEIR SPECIES OR VARIETY AND SHALL HAVE A NORMAL HABIT OR GROWTH. THEY SHALL BE SOUND, HEALTHY, AND VIGOROUS, WELL BRANCHED AND DENSELY FOLIATED WHEN IN LEAF. EXCEPT FOR CERTAIN PLANTS WITH UNUSUAL HABIT, THEY SHALL HAVE A STRAIGHT SINGLE CENTRAL LEADER. THE TRUCK SHALL HAVE ON FROST SPLITS. THEY SHALL BE FREE OF DISEASE AND INSECT PESTS, EGGS, OR LARVAE. THEY SHALL HAVE HEALTHY, WELL-DEVELOPED ROOT SYSTEMS.
 - THE CONTRACTOR SHALL SUBMIT A LIST OF THE NURSERY SOURCES FOR ALL PLANT MATERIALS. THE OWNER RESERVES THE RIGHT TO REQUIRE THE TAGGING OF ALL TREES PRIOR TO DIGGING FOR INSTALLATION ON THIS PROJECT.
 - SUBSTITUTIONS: WHEN PLANTS OF A SPECIFIED KIND OR SIZE ARE NOT AVAILABLE WITHIN A REASONABLE DISTANCE, SUBSTITUTIONS MAY BE MADE UPON REQUEST BY THE CONTRACTOR, BUT MUST BE PRIOR APPROVED BY THE CITY OF DOVER PLANNING OFFICE.
 - MEASUREMENT: DIMENSIONS OF TREES AND SHRUBS SHALL CONFORM TO ANSI Z60.1-2004
 - SIZE: ALL PLANTS SHALL CONFORM TO THE MEASUREMENT SPECIFIED ON THE PLANT LIST.
 - BALLED AND BURLAPPED PLANTS SHALL BE DUG WITH FIRM NATURAL BALLS OF EARTH, OF DIAMETER AND DEPTH TO INCLUDE MOST OF THE FIBROUS ROOTS. CONTAINER GROWN STOCK SHALL HAVE BEEN GROWN IN A CONTAINER LONG ENOUGH FOR THE ROOT SYSTEM TO HAVE DEVELOPED SUFFICIENTLY TO HOLD ITS SOIL TOGETHER FIRM AND WHOLE. NO PLANTS SHALL BE LOOSE IN THE CONTAINER.
 - . ROOT BALLS OF ALL PLANTS SHALL BE ADEQUATELY PROTECTED AT ALL TIMES FROM SUN AND DRYING WINDS OR FROST.
 - WHEN PLANTING TREES, THE CONTRACTOR SHALL REMOVE EXCESS SOIL FROM THE TOP OF THE ROOT BALL EXPOSING THE ROOT CROWN AND STRUCTURAL ROOTS. EACH TREE SHOULD HAVE A MINIMUM OF 3 STRUCTURAL ROOTS EQUALLY SPACED AROUND THE ROOT BALL, OTHERWISE IT SHOULD BE REJECTED AND SENT BACK TO NURSERY. THE ROOT CROWN MUST BE PLANTED A MAXIMUM OF 2" BELOW FINISHED GRADE. THE TOP OF THE STRUCTURAL ROOTS SHALL BE NO GREATER THAN 5" BELOW FINISHED GRADE.
 - . THE DESIGN TEAM SHALL BE NOTIFIED PRIOR TO BEGINNING PLANTING OPERATIONS.
 - 13. PLANTS WITH BROKEN ROOT BALLS OR EXCESSIVE DAMAGE TO THE CROWN SHALL BE REPLACED PRIOR TO PLANTING.
 - 14. ALL TREES SHALL BE STAKED AND GUYED ACCORDING TO ACCEPTED INDUSTRY PRACTICE.
 - . EACH TREE AND SHRUB SHALL BE PRUNED IN ACCORDANCE WITH THE ANSI Z60.1-2004 TO PRESERVE THE NATURAL CHARACTER OF THE PLANT. DO NOT PRUNE MAIN LEADERS. ALL DEAD WOOD OR SUCKERS AND ALL BROKEN OR BADLY BRUISED BRANCHES SHALL BE REMOVED.
 - . MULCH FOR TREES, SHRUBS, AND GROUND COVER SHALL BE FINELY SHREDDED OAK BARK, DARK BROWN IN COLOR, AGED AT LEAST ONE YEAR, AND CLEAN AND FREE OF WEEDS. PRE-EMERGENT WEED KILLER SHALL BE TREFLAN OR APPROVED EQUAL. APPLY WEED KILLER TO TOPSOIL PRIOR TO MULCHING BED PLANTING.
 - . TREES IN LEAF WHEN SHIPPED SHALL BE TREATED WITH ANTI-DESICCANT BEFORE LEAVING THE NURSERY.
 - . PREPARATION OF PLANTING SOIL -BEFORE MIXING, CLEAN TOPSOIL OF ROOTS, PLANTS, STONES, CLAY LUMPS, AND OTHER EXTRANEOUS MATERIALS HARMFUL OR TOXIC TO PLANT GROWTH. SOIL BACKFILL FOR TREES, SHRUBS, AND GROUND COVER SHALL BE A MIXTURE BY VOLUME OF THE FOLLOWING MATERIALS IN QUANTITIES SPECIFIED: 25 PERCENT COMPOST AND 75 PERCENT TOPSOIL. MIX IN 2 LBS OF 6-1-1 ORGANIC FERTILIZER PER TREE OR SHRUB, WITH BACKFILL MIX, UNDER AND AROUND THE ROOTBALLS OF TREES AND SHRUBS. OR MIX ORGANIC FERTILIZER WITH COMPOST AT A RATE OF 15 LBS PER CUBIC YD. BEFORE ADDING TO PLANT BACKFILL MIX. OTHER SOIL CONDITIONERS MAY BE REQUIRED PER SOIL TESTING OF FURNISHED TOPSOIL.
 - THE OWNER SHALL PROVIDE A ONE YEAR REPLACEMENT WARRANTY FOR ALL PLANT MATERIALS. TREES, SHRUB OR ANY PLANT MATERIAL THAT DIES DURING THE WARRANTY PERIOD SHALL BE REMOVED IMMEDIATELY AND REPLACED. REPLACEMENT PLANTS ARE ONLY WARRANTED FOR THE ORIGINAL TWO YEAR PERIOD, NOT AN ADDITIONAL TWO YEARS FROM REPLACEMENT
 -). ALL PLANTING SHALL BE AT THE LOCATIONS INDICATED ON THE DRAWINGS. THE CONTRACTOR SHALL BE RESPONSIBLE FOR PLANTING AT THE CORRECT GRADES, ALIGNMENT, AND TO THE INDICATED LAYOUT OF THE PLANTING BEDS. MINOR ADJUSTMENTS TO TREE LOCATION MAY BE NECESSARY DUE TO FIELD CONDITIONS AND FINAL GRADING. THE CONTRACTOR SHALL NOTIFY THE OWNER IF MAJOR ADJUSTMENTS ARE REQUIRED. COORDINATE PLANT MATERIAL LOCATIONS WITH SITE UTILITIES. SEE SITE PLAN AND GRADING, UTILITY PLANS FOR STORM, SANITARY, WATER AND GAS LINES. SEE LIGHTING PLAN FOR ELECTRICAL AND LIGHTING LAYOUT AND DETAILS. EXERCISE CARE WHEN DIGGING IN AREAS OF POTENTIAL CONFLICT WITH UNDERGROUND OR OVERHEAD UTILITIES. THE CONTRACTOR IS RESPONSIBLE FOR ANY DAMAGE DUE TO CONTRACTOR'S NEGLIGENCE AND SHALL REPLACE OR REPAIR ANY DAMAGE AT CONTRACTOR'S EXPENSE
 - . CONDITIONS DETRIMENTAL TO PLANTS: THE CONTRACTOR SHALL NOTIFY THE PROJECT REPRESENTATIVE IN WRITING OF ALL SOIL OR DRAINAGE CONDITIONS WHICH THE CONTRACTOR CONSIDERS DETRIMENTAL TO THE GROWTH OF PLANTS. HE SHALL STATE THE CONDITIONS AND SUBMIT A PROPOSAL FOR CORRECTING THE CONDITIONS, INCLUDING ANY CHANGE IN COST FOR REVIEW AND ACCEPTANCE BY THE PROJECT REPRESENTATIVE.
 - 2. IT SHALL BE THE RESPONSIBILITY OF THE CONTRACTOR TO ADEQUATELY AND PROPERLY MAINTAIN THE LANDSCAPED AREAS, WHICH RESPONSIBILITY SHALL INCLUDE WATERING, CLEANING OF WEEDS AND DEBRIS, PRUNING AND TRIMMING, REPLACEMENT OF DEAD OR DISEASED PLANTINGS AND FERTILIZING TO MAINTAIN HEALTHY GROWTH.
 - THE LANDSCAPE PLAN IS FOR LANDSCAPING INFORMATION ONLY. PLEASE REFER TO THE SITE PLAN AND GRADING/UTILITIES PLAN FOR ALL OTHER INFORMATION.

REVISIONS

2-08-2024 REVISED PER TOWN ENGINEER COMMENTS REVISED PER TOWN ENGINEER)4-23-2024 COMMENTS

ADDENDUM

DATE

✓ \ DESCRIPTION

PROFESSIONAL OFFICE

SHEET TITLE

LANDSCAPE DETAILS

TOWN OF MILLVILLE SUBMISSION AUGUST 2023 CHK'D/DESIGNER AES/DLD SHEET NO.

SCALE AS NOTED

C313 20233371.002A